

TO:

CITY COUNCIL AND PLANNING COMMISSION

CC:

TOM HATCH, GARY ARMSTRONG, AND CLAIRE FLYNN

FROM:

WILLA BOUWENS-KILLEEN. ZONING ADMINISTRATOR MBN

DATE:

DECEMBER 23, 2015

SUBJECT:

ZONING ADMINISTRATOR DECISION(S)

This is to advise you of the following decision(s) made by the Zoning Administrator within the last week. Project descriptions have been kept brief for this notice. Please feel free to contact me by e-mail at willa.bouwens-killeen@costamesaca.gov if you have any questions or would like further details.

ZA-95-19 A1 **1786 ORANGE AVENUE**

Amendment to Minor Conditional Use Permit ZA-95-19 to reinstall new rooftop telecommunication antennas (3 antennas total) on an existing screen wall; relocate an existing freestanding antenna (Air 21 Panel antenna) to be mounted on the existing screen wall: and an expansion of the ground mounted equipment within the same general area.

Approved, subject to conditions of approval.

Comments received: None.



CITY OF COSTA MESA

P.O. BOX 1200 • 77 FAIR DRIVE • CALIFORNIA 92628-1200

DEVELOPMENT SERVICES DEPARTMENT

December 23, 2015

Monica Spencer Coastal Business Group 16460 Bake Parkway, Suite 100 Irvine, CA 92618

RE:

ZONING APPLICATION ZA-95-19 A1

MINOR CONDITIONAL USE PERMIT TO MODIFY AN EXISTING ROOF TOP TELECOMMUNICATIONS FACILITY TO INSTALL ADDITIONAL ANTENNAS AND RELOCATE A FREE STANDING ANTENNA (T-MOBILE)

1786 ORANGE AVENUE, COSTA MESA

Dear Mr. Spencer:

City staff's review of your zoning application for the above-referenced project has been completed. The application, as described in the attached project description, has been approved based on the findings and subject to the conditions of approval and code requirements (attached). The decision will become final at 5:00 p.m. on <u>January 8, 2016</u>, unless appealed by an affected party, including filing of the necessary application and payment of the appropriate fee, or called up for review by a member of the Planning Commission or City Council.

If you have any questions regarding this letter, please feel free to contact the project planner, Minoo Ashabi, at (714) 754-5610, or at minoo.ashabi@costamesaca.gov.

Sincerely,

WILLA BOUWENS-KILLEEN, AICP

UBirum Mr. See

Zoning Administrator

Attachments:

Project Description

Findings

Conditions of Approval, Code Requirements, and Special District

Requirements
Applicant Letter
Conceptual Plans

CC:

Engineering Fire Protection Analyst Building Safety Division

BACKGROUND

Site Location

The property is zoned Administrative and Professional District (AP) with a General Plan land use designation of General Commercial. The project site is surrounded by residential zoned properties on all sides. The property is developed with a two-story telecommunication facility (Pacific Bell Telephone Company) with extensive roof screens that increase the overall height of the building to 45 feet. The wireless facility site currently includes the following exterior mounted facilities and equipment area:

- T-Mobile panel antennas, 2 per sector (6 total) screen mounted on the west side and east side of the building
- Equipment lease area at ground level on the north side of the building

A backup generator with an enclosure was approved in 2001 for installation in the parking area.

Previous Entitlements

On June 24, 1991 (PA-91-58), a variance was approved that allowed construction of a 9 foot high screen wall atop of the existing 36-foot high building. The roof screen was installed on the north and east side of the building and increased the overall height of the building to 45 feet.

On January 9, 1996 (ZA-95-19), the Zoning Administrator approved a minor conditional use permit allowing the installation of wireless facility consisting of six roof-top antennas on the building located at 1786 Orange Avenue.

Since additional antennas and reinstallation of existing antennas are proposed, an amendment to the Minor Conditional Use Permit ZA-95-19 is required.

PROJECT DESCRIPTION

Proposed Use

Zoning Code Sections 13-141 and 13-142 require approval of a Minor Conditional Use Permit for this installation because:

- 1. The antennas cannot be concealed; and
- 2. The location of the antennas on the rooftop of the building at a height of 45 feet exceeds the maximum allowable height of 30 feet for communication antennas.

The project includes installation of new 8-foot high dual 700 MHZ antenna on the east and north (2 per sector- 6 total) in place of 6 existing antennas. The project also includes

ZA-95-19 A1 December 23, 2015 Page 4 of 7

replacement of an existing pole mounted 4-foot high antenna with a new screen mounted AIR21 panel antenna. All antennas and structures are proposed to be painted to match the adjacent screen color. The miscellaneous equipment inside the existing equipment will be replaced with equipment of the same footprint and within the same equipment closure area.

Analysis

This site has been owned and operated by Pacific Bell for over many years. The screen mounted antennas are proposed to be replaced with new antennas with advance technology to provide better service in the area. With the 45-foot height of the existing screen wall, no additional height is required and the new antennas will be replacing existing ones with slightly larger footprint and painted to match the adjacent wall. The screen walls are mounted on the north and eastside of the building. The easterly portion of the building where a dual antenna and RUSS equipment will be installed is setback more than 150 feet from Rogers Place. The northerly dual antennas are visible from 18th Street and the properties to the immediate north of the building; however, these antennas will be mounted on the building without extending beyond the screen wall and painted to match the screen wall to minimize any aesthetic impacts.

Conditions have been included to ensure antenna frequencies do not interfere with the frequency used for Public Safety communications. Additionally, the environmental radio frequency radiation generated by the antennas will comply with the ANSI/IEEE standards.

Per Policy No. B-06-06 of the Development Services Department, all new buildings over three stories in height are required to include specific in-building public safety radio facilities. A condition of approval is include addressing this requirement.

FINDINGS

- A. The information presented complies with Costa Mesa Municipal Code Section 13-29(g)(2) in that:
 - 1. The proposed use is compatible with developments in the same general area. The new replaced antennas will be mounted on the equipment screen wall and painted to match the building. The upgraded equipment will be located within the existing closures at the ground level and at rooftop locations. The existing and replacement antennas are proposed to be painted to match the building.
 - 2. Granting the Minor Conditional Use Permit will not be detrimental to the health, safety and general welfare of the public or other properties or improvements within the immediate vicinity since the antenna frequencies will comply with ANSI/IEEE standards. Conditions have also been added to certify that the antennas do not interfere with frequencies used by the City for public safety purposes. The antenna frequencies comply with all Federal standards for radio frequency emissions in accordance with the Telecommunications Act of 1996 and subsequent amendments,

as well as any other applicable requirements imposed by the State and Federal agencies.

- 3. Granting the Minor Conditional Use Permit will not allow a use, density or intensity that is not in accordance with the General Plan designation for the property. The new telecommunications antennas will be co-located on the rooftop and placed at the same height as the existing antennas which are mounted to the screen wall. The proposed cabinet will be placed within the existing equipment area. With the mounting of the antennas on the screen wall, painted to match the wall, the rooftop equipment will not be readily visible from the immediate surroundings; therefore, the new antennas and related equipment are not deemed visually obtrusive.
- B. The project has been reviewed for compliance with the California Environmental Quality Act (CEQA), the CEQA Guidelines, and the City environmental procedures, and has been found to be exempt under Section 15311, Class 11, Accessory Structures, of the CEQA Guidelines.
- C. The project is exempt from Chapter XII, Article 3, Transportation System Management, of Title 13 of the Costa Mesa Municipal Code.

CONDITIONS OF APPROVAL

- Plng. 1. The conditions of approval and Code requirements of Zoning Application (ZA-95-19 A1) shall be blueprinted on the face of the site plan of the plan check submittal package.
 - 2. Any future modifications to the equipment or antennas shall be done only with the prior approval of Planning staff and may require filing and approval of a minor conditional use permit.
 - 3. All existing, replacement and proposed and antennas mounted to the existing screen wall shall be painted to match the color of the building/screen wall upon which they are installed
 - 4. The cabinet(s) shall be located in the existing equipment area and shall not be visible from off-site.
 - 5. The applicant shall provide a 24-hour phone number to which interference problems may be reported.
 - 6. The applicant shall provide a "single point of contact" in its Engineering and Maintenance Departments to ensure continuity on all interference issues. The name, telephone number, fax number, and email address of that person shall be provided to the City's designated representative.
 - 7. The applicant shall contact the Planning Division to arrange for an inspection of the site prior to the final building inspection(s). This inspection is to confirm that the conditions of approval and Code requirements have been satisfied.
 - 8. The applicant shall ensure that lessee or other user(s) shall comply with the terms and conditions of this permit and shall be responsible for the failure of any lessee or other users under the control of applicant to comply.

- 9. The wireless telecommunications facility and all associated equipment shall be completely removed upon discontinuance of use. The applicant shall notify the Planning Division when this occurs and obtain the necessary demolition permits to remove the wireless facility and associated equipment.
- The applicant recognizes that the frequencies used by the cellular facility Police 10. located at the subject property are extremely close to the frequencies used by the City of Costa Mesa for Public Safety. This proximity will require extraordinary "comprehensive advanced planning and frequency coordination" engineering measures to prevent interference, especially in the choice of frequencies and radio ancillary hardware. This is encouraged in the "Best Practices Guide" published by the Association of Public Safety Communications Officials, International, Inc. (APCO), and as endorsed by the federal Communication Commission (FCC). Prior to the issuance of any permits to install the facility, applicant shall meet in good faith to coordinate the use of frequencies and equipment with the Communications Division of the Orange County Sheriff-Coroner Department to minimize, to the greatest extent possible, any interference with the Public Safety 800 MHz Countywide Coordinated Communications System (CCCS). Similar consideration shall be given to any other existing or proposed wireless communications facility that may be located on the subject property.
 - At all times, the applicant shall not prevent the City of Costa Mesa from having adequate spectrum capacity on the City's 800 MHz radio frequency.

CODE REQUIREMENTS

The following list of federal, state, and local laws applicable to the project has been compiled by staff for the applicant's reference. Any reference to "City" pertains to the City of Costa Mesa.

- Ping.
- 1. Approval of the zoning application is valid for one (1) year from the effective date of this approval and will expire at the end of that period unless applicant establishes the use by obtaining building permits for the authorized construction and initiates construction. If the applicant is unable to obtain building permits within the one-year time period, the applicant may request an extension of time. The Planning Division must receive a written request for the time extension prior to the expiration of the planning application.
- 2. All construction-related activity shall be limited to between the hours of 7 a.m. and 7 p.m., Monday through Friday, and 9 a.m. to 6 p.m. Saturday. Construction is prohibited on Sundays and federal holidays. Exceptions may be made for activities that will not generate noise audible from off-site, such as painting and other quiet interior work.
- 3. Antennas shall comply with the Antenna Development Standards in Section 13-142 of the Costa Mesa Zoning Code.
- Bldg. 4. Comply with the requirements of the 2013 California Building Code, 2013 California Electrical Code, 2013 California Energy Code (or the applicable adopted California Building Code, California Electrical Code, and California

ZA-95-19 A1 December 23, 2015 Page 7 of 7

Energy Code at the time of plan submittal or permit issuance), and California Code of Regulations also known as the California Building Standards Code, as amended by the City of Costa Mesa.

Provide a structural analysis and framing details designed by a licensed California Civil Engineer.

Bus. Lic. 5. All contractors and subcontractors must have valid business licenses to do business in the City of Costa Mesa. Final inspections will not be granted until all such licenses have been obtained.



Wireless Telecommunications Facility Application Letter of Justification

Modifications to Existing T-Mobile Wireless Facility
Minor Conditional Use Permit ZA 95-19
LA02049A – CM049 LE103
1786 Orange Ave., Costa Mesa, CA 92626

T-Mobile is proposing to add (3) new 8-foot antennas and (3) RRUs on the existing rooftop. Replace miscellaneous equipment inside the existing equipment cabinet.

The proposed use of this existing wireless facility is to supply surrounding T-Mobile customer's greater wireless coverage through new wireless technologies. The proposed antennas will be mounted on the existing rooftop painted to match existing located at 1786 Orange Ave. These antennas will operate throughout the day to continually provide coverage to the surrounding area. There will be minimal visual impact to the surrounding area. The RF emissions from this facility will not pose any threats to the surrounding people or area.

The proposed project will not alter the current general use of this facility and the modifications will have minimal visual impact on the surrounding property. These modifications will not cause unusual noise, traffic, or conditions in the surrounding area.

The proposed wireless telecommunication facility modification will provide a service that is essential and beneficial to the community within the vicinity of the subject property. T-Mobile will enhance their wireless network with the proposed site, allowing it the surrounding community greater access to wireless services. The increase in cellular usage and the demand for cellular technology has increased the need for updated wireless facilities to handle the call load, data, and internet usage. Therefore, a wireless facility would not be detrimental to the public health, safety, or general welfare, it would instead increase the public safety and general welfare through increased coverage and upgraded technologies.



Wireless Telecommunications Facility Application Project Description

Modifications to Existing T-Mobile Wireless Facility LA02049A – CM049 LE103 1786 Orange Ave., Costa Mesa, CA 92626

T-Mobile is proposing to relocate (1) existing pipe mounted 4-foot antenna and Twin TMA on Sector A the North side of the building to the existing screen wall on the rooftop. Add (3) new 8-foot antennas (painted to match) and (3) RRUs on the existing antenna structure on the rooftop on all Sectors. Replace miscellaneous equipment inside the existing equipment cabinet.

T--Mobile-®

SITE NUMBER: LA02049A

SITE NAME: CM049 LE103

SITE TYPE: **ROOF TOP MOUNT** CITY:

COUNTY:

JURISDICTION:

VICTORIA ST

PLUMER ST

COSTA MESA ORANGE COUNTY **COSTA MESA**

VICINITY MAP:

PROJECT SUMMARY:

SITE ADDRESS:

1786 ORANGE AVE., COSTA MESA, CA 92626

PROPERTY OWNER:

AT&T NETWORK REAL ESTATE ADMINISTRATION 2600 CAMING ROAD 3E400GG SAN RAMON, CA 94583

APPLICANT:

T-MOBILE WEST CORPORATION

PROJECT DESCRIPTION (702Cu RFDS V.2):

THIS PROJECT INCLUDES THE MODIFICATIONS TO AN EXISTING T-MOBILE WIRELESS FACILITY, INCLUDING:

- . RELOCATE (1) (E) AIR21 PANEL ANTENNA FROM SECTOR "A"
- ADD (3) NEW 8' TALL DUAL 700MHz ANTENNAS TO THE EXISTING ANTENNA STRUCTURE. ADD (3) NEW 700MHz RRUS11B12 TO THE EXISTING ANTENNA
- REPLACE (1) DUL20 WITH (1) DUS41 NSIDE THE EXISTING EQUIPMENT CABINET.
 USE SPARE FIBER JUMPERS
- INSTALL XMU INSIDE (E) CABINET

NO A/C ELECTRICAL WORK IS PROPOSED

BUILDING SUMMARY:

OCCUPANCY CLASSIFICATION: TYPE OF CONSTRUCTION: B (TELEPHONE EXCHANGE) ASSESSORS PARCEL NUMBER

425-392-31 LATITUDE: LONGITUDE: 33-63754794 -117-91582000

LEASE AREA:

EQUIPMENT AREA:
SECTOR 'B':
SECTOR 'C'
TOTAL:

CONSULTING TEAM:

SAC/ZONING/PERMITTING;

ARCHITECTURAL & ENGINEERING:

COASTAL BUSINESS GROUP, INC. 16150 SCIENTIFIC WAY IRVINE, CA 92618 CONTACT: JORDON DIBIASE CDG-CONNELL DESIGN GROUP, L.L.C. 26455 RANCHO PKWY SOUTH PHONE: (949) 306-4644

PHONE: (949) 336-1550
EMAIL: jdibiase@coastalbusinessgroup.net

SHEET INDEX:

SHEET NUMBER: DESCRIPTION:

ABBREVIATIONS, SYMBOLS, GENERAL NOTES & SPECIFICATIONS T-2 CONDITIONS OF APPROVAL 1-3 SITE PLAN. (F) FOUIPMENT LAYOUT & ANTENNA SCHEDULE A - 1

EXISTING ENLARGED SITE PLAN $A - 1_{-}1$ A-1_2 PROPOSED ENLARGED SITE PLAN (E) & (P) ANTENNA LAYOUTS A-2ARCHITECTURAL ELEVATIONS A-3:1 ARCHITECTURAL ELEVATIONS ARCHITECTURAL DETAILS

A-5ARCHITECTURAL DETAILS ROOF PROTECTION DETAIL PLAN REVIEW COMMENTS

APPROVALS:

THE FOLLOWING PARTIES HEREBY APPROVE AND ACCEPT THESE DOCUMENTS AND AUTHORIZE THE CONTRACTOR TO PROCEED WITH THE CONSTRUCTION DESCRIBED HEREIN, ALL CONSTRUCTION DOCUMENTS ARE SUBJECT TO REVIEW BY THE LOCAL BUILDING DEPARTMENT AND ANY CHANGES AND MODIFICATIONS THEY MAY IMPOSE.

I		PRINT NAME	SIGNATURE	DATE
I	LANDLORD			
١	DEVELOP, MGR	·		=====
I	CONST. MGR			
I	ZONING MGR			
ı	RF ENGINEER			
I	OPERATIONS			
	SAC REP.			
	UTILITIES			

DRIVING DIRECTIONS:

DIRECTIONS FROM THE LOCAL T-MOBILE OFFICE:

START OUT GOING NORTHWEST ON MCGAW AVE TOWARD ARMSTRONG AVE.

PROJECT AREA

- 2 TAKE THE 3RD LEFT ONTO RED HILL AVE
- 3. TURN RIGHT ONTO MACARTHUR BLVD.
- 4. MERGE ONTO CA-55 S TOWARD NEWPORT BEACH
- LURN LEFT ONTO 19TH ST
- 6. TURN RIGHT ONTO ORANGE AVE
- 1786 DRANGE AVE IS ON THE LEFT

APPLICABLE CODES

BUILDING CODE: CALIFORNIA BUILDING CODE 2013

ALL WORK IS TO COMPLY WITH THE 2013 CALIFORNIA BUILDING CODE (CBC)

TIA/EIA~222-1996-F LIFE SAFETY CODE NFPA-101, 607 COMMERCIAL BUILDING GROUNDING AND BONDING REQUIREMENTS FOR TELECOMMUNICATIONS AISC - CONSTRUCTION MANUAL, 9TH EDITION OR LATER.

CEC (CALIFORNIA ELECTRICAL CODE) 2013

T··Mobile·





NO.	- DATE:	-DESCRIPTION:-	-BY:
0	09/08/14	90% CD'S	HL
1	10/08/14	100% CD'S	HL
2	11/11/14	100% CD'S	DC
3	2/03/15	100% CD'S	GN
4	6/26/15	100% CD'S	FC
5	07/16/15	100% CD'S	JPC
6	08/19/15	100% CD'S	SA
7	09/16/15	100% CD'S	DC
8	09/28/15	100% CD'S	SA
9	10/30/15	100% CD'S	SA

- SITE INFORMATION: -

CM049 LE103

LA02049A

1786 ORANGE AVE., COSTA MESA, CA 92626

- SHEET TITLE: -

TITLE SHEET

- SHEET NUMBER: -

Γ-1

GENERAL

1. THESE NOTES SHALL BE CONSIDERED A PART OF THE WRITTEN SPECIFICATIONS.

2. THE CONTRACTOR SHALL NOTIFY ARCHITECT/ENGINEER OF ANY ERRORS, OMISSIONS, OR DISCREPANCIES AS THEY MAY BE DISCOVERED IN THE PLANS, SPECIFICATIONS, & NOTES PRIOR TO STARTING CONSTRUCTION, INCLUDING BUT NOT LIMITED BY DEWOLITION, THE CONTRACTOR SHALL BE RESPONSIBLE FOR CORRECTION ANY ERRORS, OMISSION, OR INCONSISTENCY AFTER THE START OF CONSTRUCTION WHICH HAS NOT BEEN BROUGHT TO THE ATTENTION OF THE ARCHITECT/ENGINEER AND SHALL INCUR ANY EXPENSES TO RECITEY THE SITUATION. HE METHOD OF CORRECTION SHALL BE APPROVED BY THE ARCHITECT/ENGINEER.

3, PRIOR TO STARTING CONSTRUCTION THE CONTRACTOR HAS THE RESPONSIBILITY TO LOCATE ALL EXISTING UTILITIES, WHETHER OR NOT SHOWN ON THE PLANS, AND TO PROTECT THEM FROM DAMAGE, THE CONTRACTOR OR SUBCONTRACTOR SHALL BEAR THE EXPENSE OF REFAMING OR REPAIRING ON REPAIRING ON THE WORK.

4. A COPY OF THE APPROVED PLANS SHALL BE KEPT IN A PLACE SPECIFIED BY THE GOVERNING AGENCY, AND BY LAW SHALL BE AVAILABLE FOR INSPECTION AT ALL TIMES, IT IS THE CONTRACTORS RESPONSEILT TO ENSURE ALL CONSTRUCTION SETS REFLECT THE SAME INFORMATION AS THE APPROVED PLANS. THE CONTRACTOR SHALL ALSO MAINTAIN ONE SET OF PLANS AT THE STEF FOR THE PURPOSE OF DOZUMENTING ALL AS-BULLT CHANGES, REVISIONS, ADDENDUM'S, OR CHANGE ORDERS, THE CONTRACTOR SHALL FORWARD THE AS-BULLT DRAWINGS TO THE ARCHITECT/ENGINEER AT THE CONCLUSION OF THE PROJECT.

5, THE CONTRACTOR SHALL BE RESPONSIBLE FOR THE COMPLETE SECURITY OF THE SITE FROM START OF PROJECT TO COMPLETION OF PROJECT.

6. THE CONTRACTOR IS RESPONSIBLE TO PROVIDE TEMPORARY POWER, WATER, AND TOLLET "ACILLITES," $% \left(1,0\right) =0$

7. ALL CONSTRUCTION THROUGH THE PROJECT SHALL CONFORM TO THE 2013 CBC AND ALL OTHER GOVERNING CODES.

8, THE CONTRACTOR SHALL BE RESPONSIBLE FOR COMPLYING WITH ALL SAFETY PRECAUTIONS AND REGULATIONS DURING THE WORK. THE ENGINEER WILL NOT ADVISE ON NOR PROVIDE DIRECTION AS TO SAFETY PRESAUTIONS AND PROGRAMS.

9 THE CONTRACTOR SHALL SUPERVISE AND COORDINATE ALL WORK, USING HIS PROFESSIONAL KNOWLEDGE AND SKILLS, HE IS SOLELY RESPONSIBLE FOR ALL CONSTRUCTION MEANS, METHODS, TECHNIQUES, PROCEDURES AND SEQUENCING AND COORDINATING ALL PORTIONS OF THE WORK

11 ALL DIMENSIONS TAKE PRECEDENCE OVER SCALE UNLESS OTHERWISE NOTED

12 THE CONTRACTOR SHALL PROVIDE ALL NECESSARY BLOCKING, BACKING, FRAMING, HANGERS OR SUPPORTS FOR INSTALLATION OF ITEMS NDICATED ON THE

13. THE CONTRACTOR SHALL PROVIDE THE FIRE MARSHALL APPROVED MATERIALS TO FILL/SEAL PENETRATIONS THROUGH FIRE RATED ASSEMBLIES

14, NEW CONSTRUCTION ADDED TO EXISTING CONSTRUCTION SHALL BE MATCHED IN FORM, TEXTURE, WATERIAL AND PAINT COLOR EXCEPT AS NOTED IN THE PLANS.

15 WHERE SPECIFIED, MATERIALS TESTING SHALL BE TO THE LATEST STANDARDS AVAILABLE AS REQUIRED BY THE LOCAL GOVERNING AGENCY RESPONSIBLE FOR RECORDING THE RESULTS.

16, ALL GENERAL NOTES AND STANDARD DETAILS ARE THE MINIMUM REQUIREMENTS TO BE USED IN CONDITIONS WHICH ARE NOT SPECIFICALLY SHOWN OTHERWISE.

17. ALL DEBRIS AND REFUGE IS TO BE REMOVED FROM THE PROJECT DAILY, PREMISES SHALL BE LEFT N A CLEAN BROOM FINISHED CONDITION AT ALL TIMES.

18, ALL SYMBOLS AND ABBREVIATIONS ARE CONSIDERED CONSTRUCTION INDUSTRY STANDARDS. IF A CONTRACTOR HAS A QUESTION REGARDING THER EXACT MEANING THE ARCHITECT/ENGINEER SHALL BE NOTHFIED FOR CLARBIFICATIONS.

19, THE ENCINEER SHALL NOT BE RESPONSIBLE FOR THE METHODS, TECHNIQUES AND SEQUENCES OF PROCEDURES TO PERFORM THE WORK, THE SUPERVISION OF THE WORK IS THE SOLE RESPONSIBILITY OF THE CONTRACTOR

20. CONTRACTORS SHALL VISIT THE SITE PRIOR TO BID TO ASCERTAIN CONDITIONS WHICH MAY ADVERSELY AFFECT THE WORK OR COST THEREOF.

21. THE CONTRACTOR SHALL FIELD VERIFY THE DIMENSION, ELEVATION, ETC.
NECESSARY FOR THE PROPER CONSTRUCTION AND AUGMNENT OF THE NEW PORTION
OF THE WORK TO THE EXISTING WORK, THE CONTRACTOR SHALL MAKE ALL
MEASUREMENTS NECESSARY FOR FABRICATION AND ERECTION OF STRUCTURAL
MEMBERS, AND DISCREPANCY SHALL BE IMMEDIATELY BROJENT TO THE ATTENTION OF THE ARCHITECT/ ENGINEER

22, ALL EXISTING ACTIVE SEWER, WATER, GAS, ELECTRIC, AND OTHER UTILITIES WHERE ENCOUNTERED IN THE WORK SHALL BE PROTECTED AT ALL TIMES, AND WHERE REQUIRED FOR THE PROPER EXECUTION OF THE WORK, SHALL BE RELOCATED AS DIRECTED BY ENGINEERS EXTREME CAUTION SHOULD BE USED BY

23, ALL EXISTING INACTIVE SEWER, WATER, GAS, ELECTRIC AND OTHER UTILITIES, WHICH INTERFERE WITH THE EXECUTION OF THE WORK, SHALL BE REMOVED AND SHALL BE CAPPED, PLUGGED OR OTHERWISE DISCONTINUED AT POINTS WHICH WILL NOT INTERFERE WITH THE EXECUTION OF THE WORK, SUBJECT TO THE APPROVAL OF THE ENGINEER.

24 NO CHANGES ARE TO BE MADE TO THESE PLANS WITHOUT THE KNOWLEDGE AND WRITTEN CONSENT OF THE ARCHITECT/ ENGINEER. UNAUTHORIZED CHANGES RENDER "HESE DRAWINGS VOID.

25. ANY REFERENCE TO THE WORDS APPROVED, OR APPROVAL IN THESE DOCUMENTS SHALL BE HERE DEFINED TO MEAN GENERAL ACCEPTANCE OR REVIEW AND SHALL NOT RELIEVE. THE CONTRACTOR AND/OR HIS SUB-CONTRACTORS ANY LIABILITY IN FURNISHING THE REQUIRED MATERIALS OR LABOR SPECIFIED.

26, IT SHALL BE THE RESPONSIBILITY OF THE CONTRACTOR TO LOCATE ALL EXISTING UTILITIES WHETHER SHOWN HEREON OR NOT, AND TO PROTECT THEM FROM DAMAGE, THE CONTRACTOR SHALL BEAR ALL EXPENSE OF REPAIR OR REPLAZEMENT IN COMJUNCTION WITH THE EXCLUTION OF THIS WORK. 10, GENERAL CONTRACTOR SHALL NOTIFY THE ENGINEER AND ARCHITECT MMEDIATELY OF ANY DISCREPANCIES FOUND WITHIN THE CONTRACT DOCUMENTS, PRIOR TO STARTING WORK.

SITE PREPARATION NOTES:

IL THE PREPARATION OF THE SITE FOR CONSTRUCTION SHALL INCLUDE THE REMOVAL OF ALL BROKEN CONCRETE, TREE TRUNKS AND ANY CITIER DEBRIS THAT WOULD BE DAMAGING TO THE FOOTINGS OF THE NEW STRUCTURE.

2. BACK FILLING AT TRENCHES SHALL BE OF CLEAN, STERILE SOIL HAVING A SAND EQUIVALENT OF 30 OR GREATER, BACK FILLING SHALL BE DONE IN 8 INCH LAYERS, MOISTURE CONDITIONED AND PROPERLY COMPACTED, ADEQUATE DRAINAGE SHALL BE PROVIDED SUCH THAT NO PONDING OCCURS,

3, ALL FOUNDATION FOOTINGS SHALL EXTEND INTO AND BEAR AGAINST NATURAL UNDISTURBED SOIL OR APPROVED COMPACTED FILL, FOOTINGS SHALL EXTEND INTO SOIL DEFTH AS INDICATED IN PLANS.

4. SHOULD ANY LOOSE FILL, EXPANSIVE SOIL, GROUND WATER OR ANY OTHER UNEXPECTED CONDITIONS BE ENCOUNTERED DURING THE EXCAVATION FOR THE NEW FOUNDATION. THE ARCHITECT/EMGINEER SHALL BE NOTIFIED AND ALL FOUNDATION WORK SHALL CEASE IMMEDIATELY.

 5°_c within an area 4 minimum of 5 feet beyond the building limits, excaval a minimum of 4" of existing sole, remove all organics, pavement, roots, debris and otherwise unsuitable material,

6, THE SURFACE OF THE EXPOSED SUBGRADE SHALL BE INSPECTED BY PROBING OR TESTING TO CHECK FOR POCKETS OF SOFT OR UNIVITABLE MATERIAL, EXCAMATE UNIS.IITABLE SOIL AS DIRECTED BY THE GEOTECHNICAL ENGINEER/TESTING AGENCY,

7. PROOFROLL THE SURFACE OF THE EXPOSED SUBGRADE WITH A LOADED TANDEM AXLE DUMP TRUCK, REMOVE ALL SOILS WHICH PUMP OR DO NOT COMPACT. REOPERLY AS DIRECTED BY THE GEOTICANICAL ENGINEER/TESTING AGENCY.

8, FILL ALL EXCAVATED AREAS WITH APPROVED CONTROLLED FILL PLACE IN 8° LOOSE LIFTS AND THE MAXIMLM DRY DENSITY IN ACCORDANCE WITH ASTM D-698. COMPACT TO A MINIMUM OF 90% RELATIVE COMPACTON

9. THE STRUCTURAL DRAWINGS HERE N REPRESENT THE FINISHED STRUCTURE. THE CONTRACTOR SHALL PROVIDE ALL TEMPORARY GUYING AND BRACING REQUIRED TO REPCT AND HOLD THE STRUCTURE IN PROPER ALLGMENT UNTIL ALL STRUCTURAL WORK AND CONNECTIONS HAVE BEEN COMPLETED. THE INVESTIGATION, DESIGN, SAFETY, ADEQUACY AND INSPECTION OF ERECTION BRACING, SHORING, TEMPORARY SUPPORTS, ETC., IS THE SOLE RESPONSIBILITY OF THE CONTRACTOR.

10 PRIOR TO STARTING CONSTRUCTION, THE CONTRACTOR SHALL PROTECT ALL AREAS FROM DAMAGE WHICH MAY OCCUR DURING CONSTRUCTION, ANY DAMAGE TO NEW OR EXISTING SURFACES, STRUCTURES OR EQUIPMENT SHALL BE IMMEDIATELY REPAIRED OR REPLACES TO THE SATISFACTION OF THE "ROPERTY OWNER, THE CONTRACTOR SHALL BEAR THE EXPENSE OF REPAIRING OR REPLACING ANY DAMAGE

11. WHEN REQUIRED STORAGE OF MATERIALS OCCURS, THEY SHALL BE EVENLY DISTRIBUTED OVER THE FLOOR OR ROOF SO AS NOT TO FEARCH THE DESIGNED LIVE LOADS FOR THE STRUCTURE. TEMPORARY SHORING OR BRACING SHALL BE PROVIDED WHERE THE STRUCTURE OR SOIL HAS NOT ATTAINED THE DESIGN STRENGTH FOR THE CONDITIONS PRESENT.

12, BEFORE PROCEEDING WITH ANY WORK WITHIN THE EXISTING FACILITY, THE CONTRACTOR SHALL FAMILIARIZE HIMSELF WITH EXISTING STRUCTURAL AND OTHER CONDITIONS IT SHALL BE THE CONTRACTOR'S RESPONSIBILITY TO PROVIDE ALL NECESSARY BRACING, SHORING AND OTHER SAFEGUARDS TO MAINTAIN ALL PARTS (THE EXISTING WORK IN A SAFE CONDITION DURING THE PROCESS OF DEMOLITION AND CONSTRUCTION AND TO PROTECT FROM DAMAGE THOSE PORTIONS OF THE EXISTING WORK WHICH ARE TO REMAIN.

SUBMITIALS: SUBMITIALS FOR SHOP DRAWINGS, MILL TESTS, PRODUCT DATA, ETC-FOR IFEMS DESIGNED BY THE ARCHITECT/ ENGINEER OF RECORD SHALL BE MADE TO THE ARCHITECT/FORMERER PRIOR TO CONSTRUCTION. THE CONTRACTOR SHALL REVIEW THE SUBMITIAL BEFORE FORWARDING TO "INFO ARCHITECT, SUBMITIALS SHALL BE MADE IN ADVANCED TO ARCHITECTI-ROMERER, SUBMITIALS REQUIRED FOR EACH SECTION OF THESE NOTES ARE SPECIFIED IN THAT SECTION.

SHOP DRAWING REVIEW:

REVIEW BY THE ARCHITECT/ENGINEER IS FOR GENERAL COMPLIANCE WITH THE DESIGN CONCEPT AND THE CONTRACT DOCUMENTS. MARKINGS OR COMMENTS SHALL NOT BE CONSTRUED AS RELIEVING THE CONTRACTOR FROM COMPLIANCE WITH THE PROJECT PLANS AND SPECIFICATIONS, NOR DEPARTURES THEREFROM, THE CONTRACTOR REMAINS RESPONSIBLE FOR DETAILS AND ACCURACY, FOR CONFIRMING AND CORRELATING ALL QUANTITIES AND DIMENSIONS, FOR SELECTION FABRICATION PROCESSES.

ACCESSIBILITY NOTE:

THE TELECOMMUNICATIONS EQUIPMENT SPACE SHOWN HEREON THESE PLANS IS NOT CUSTOMARILY DECUPIED. WORK TO BE PERFORMED IN THIS FACILITY CANNOT REASONABLY BE PERFORMED BY PERSONS WITH A SEVERE IMPAIRMENT: WOBLITY, SIGHT, AND/OR HEARING, THEREFORE, PER 2013 CALIFORNIA BUILDING CODE SECTION 1.1038, 1 EXCEPTION 1. THIS FACILITY SHALL BE EXEMPTED FROM ALL TITLE 24 ACCESS REQUIREMENTS:

BID WALK NOTES:

1. CONTRACTOR TO FIELD VERIFY ALL EXISTING CONSTRUCTION CONDITIONS BEFORE SUBMITTAL OF FINAL BIDS, START OF CONSTRUCTION AND/OR FABRICATION. AFTER THOROUGHLY EXAMINING THE PLANS AND EXISTING SITE CONDITIONS NOTIFY THE ENSINEER IN WRITING OF ANY CMISIONS/DISCREPANCES, OR ANY LIFEMS NEEDING CLARIFICATION PRIOR TO SUBMITTING FINAL BIDS.

IF THE ENGINEER IS NOT NOTIFIED OF ANY OMISIONS/DISCREPANCIES OF 2. THE EMPIRIER IS NOT MOTHER OF ANY COMMISIONS/DISCREPANCES OR CONFIRMED THAT THE CONTRACTOR HAS CONSIDERED ALL ITEMS THAT WILL BE CONFIRMED THAT THE CONSTRACTION OF THE SITE UNDER THE MOST STRINGENT CONDITIONS. THE CONSTRACTION OF THE SITE UNDER THE MOST STRINGENT CONDITIONS. THE CONTRACTOR WILL NOT BE ENTITLED TO ANY ADDITIONAL COMPENSATION AFTER FINAL BIOS HAVE BEEN SUBMITTED AND AWARDED FROM CARRIER.

STRUCTURAL STEEL:

1. ACL MATERIALS AND WORKMANSHIP SHALL BE IN ACCORDANCE WITH THE LATEST REVISED EDITION OF THE AISC MANUAL OF STEEL CONSTRUCTION, WHICH INCLUDES THE SPECIFICATION FOR STRUCTURAL STEEL BUILDINGS, THE CODE OF STANDARD FRACTICE AND THE AWS STRUCTURAL WELDING CODE. DENTIFY AND MARK STEEL PER CSC 2203.

3 GROUTING OF COLUMN BASE PLATES: BASE PLATES SHALL BE DRYPACKED OR CROUTED WITH NON-SHRINK, NON-FERRCUS CROUT, MINIMUM COMPRESSIVE STRENGTH SHALL BE 4,000 °SI AT 28 DAYS, ALL SURFACES SHALL BE PROPERLY CLEAMED CF FOREIGN MATERIAL PRICE TO GROUTING.

4. ALL EXPOSED WELDS SHALL BE FILLED AND GROUND SMCOTH WHERE METAL COULD COME IN CONTACT WITH THE PUBLIC.

5. NO HOLES OTHER THAN THOSE SPECIFICALLY DETAILED SHALL BE ALLOWED THRU STRUCTURAL STEEL MEMBERS. BOLT HOLES SHALL CONFORM TO AISC. SPECIFICATION, AND SHALL BE STANDARD HOLES UNLESS OTHERWISE NOTED, NO CUTTING OR BURNING OF STRUCTURAL STEEL WILL BE PERMITTED WITHOUT PRIOR

6. WELDING: CONFORM TO AWS DI 1. WELDERS SHALL BE CERTIFIED IN ACCORDANCE WITH WABO REQUIREMENTS. USE E70 ELECTRODES OF TYPE REQUIRED. FOR MATERIALS TO BE WELDED.

ASTM A307 BOLTS SHALL BE INSTALLED "SNUG TIGHT" PER AISC. SECTION RCSC 8(C) ASTM A325 BOLTS SHALL CONFORM TO THE RCSC SPECIFICATION SECTION 8

8. FABRICATION: CONFORM TO AISO SPECIFICATION SEC M2. "FABRICATION" AND AISO CODE SEC 6 "FABRICATION AND DELIVERY" PERFORM WORK ON PREMISES OF A FABRICATION APPROVED BY THE BUILDING OFFICIAL.

9. GALVANIZING: ALL EXPOSED STEEL OUTSIDE THE BUILDING ENVELOPE SHALL BE HOT-DIPPED GALVANIZED. APPLY FIELD TOUCH-UPS PER SPECIFICATIONS, PER ASTM

STRUCTURAL STEEL:

MATERIALS: CONFORM TO

ANCHOR BOLTS (HEADED): ANCHOR BOLTS (J-TYPE): C-, M-, AND ANGLE SHAPES: ASTM A36

DEFORMED WELDED WIRE FABRIC: ASTM A497

FPOXY & EXPANSION ANCHORS: HILTI OR FOUVALENT EMBECO OR EQUIVALENT HIGH-STRENGTH BOLTS: ASIM AJ25SC OR (AJ25N)

ASTM 436 OTHER STRUCTURAL SHAPES:

REINFORCING BARS: ASTM 4615 GRADE 6C, DEFORMED BARS

SMOOTH WELDED WIRE FABRIC: ASTM 4185

STRUCTURAL WF SHAPES: STEEL PIPE: ASTM A572-CR50 ASTM A53, GRADE 3

TIE W'RE:
TUBE STEEL & PIPE COLUMNS:

16,5 GAGE OR HEAVIER, BLACK ANNEALED
ASTM A5CO, GRADE B

E70XX ASTM 4992, GRADE 50

STRUCTURAL STEEL NOTES:

2. ALL FRAMING CONNECTORS SUCH AS CONCRETE ANCHORS, HOLD—DOWNS, POST BASES, FRAMING CAPS, HANGER AND OTHER MISCELLANEOUS STRUCTURAL METALS SHALL BE AS MANUFACTURED BY SIMPSON STRONG TIE CO. OR APPROVED EQUAL

ELECTRICAL COMMENTS:

I_ ALL ABANDONED AND UNUSED CARRIERS AC/DC, DATA, FIBER, COAXIAL CABLING AND SUPPORTS SHALL BE COMPLETELY REMOVED AS REQUIRED, ALL MODIFICATION TO THE ELECTRICAL DISTRIBUTION PARLES SHALL BE LABELED AS REQUIRED.

T··Mobile •

- PLANS PREPARED BY: -



(949) 753-8807 OFFICE - (949) 753-8833 FAX

- CONSULTING GROUP: -



rNO	- DATE:-	-DESCRIPTION:	BY:
0	09/08/14	90% CD'S	HL
1	10/08/14	100% CD'S	HL
2	11/11/14	100% CD'S	DC
3	2/03/15	100% CD'S	GN
4	6/26/15	100% CD'S	FC
5	07/16/15	100% CD'S	JPC
6	08/19/15	100% CD'S	SA
7	09/16/15	100% CD'S	DC
8	09/28/15	100% CD'S	SA
9	10/30/15	100% CD'S	SA

- SITE INFORMATION: -

CM049 LE103

LA02049A

1786 ORANGE AVE., COSTA MESA, CA 92626

-SEAL: -

- SHEET TITLE: -

ABBREVIATIONS, SYMBOLS, GENERAL NOTES & **SPECIFICATIONS**

- SHEET NUMBER: -

ABBREVIATIONS & SYMBOLS

X DOOR NUMBER

MECHANICAL UNIT

SCALE:

X X FENCING

T-T-T-T-T- TELCO SERVICE

X AREA AND/OR ROOM NUMBER -E-E-E-E-E-E-E-ECTRICAL SERVICE

GENERAL NOTES & SPECIFICATIONS

SCALE: N.T.S.

2



THE PLANNING CENTER

MEMORANDUM

Date: January 16, 1996

12

TO: Jim Kelly FROM: Marie Luna

SUBJECT: Follow-up on Approved CM-049-09 (Orange, Costa Mesa)

- On January 9, 1996, the Zoning Administrator of the City of Costa Mesa conditionally approved Minor Conditional Use Permit ZA 95-19 to allow the installation and operation of a wireless facility consisting of six (6) roof-top antennas on the building located at 1786 Orange Avenue (see approval letter dated January 9, 1996. Attachment 1). The action will become final on January 17, 1996.
- The City will be forwarding within the next few days a copy of the conceptually approved site plan. This item was inadvertantly omitted from the approval letter package we received. As soon as I receive it I will forward it to you.

Conditions of Approval

The conditions of approval have been reviewed. The conditions related to construction and

- The antennas shall be painted to match the screen (see Condition 1 of Attachment 1).
- The two southeasterly-most antennas not attached to the existing mechanical screen shall be placed on individual vertical poles (see Condition 2 of Attachment 1).
- The street address shall be displaced on the complex. Street address numberals shall be a minimum 6" in height with not less than 1/2" stroke and shall contrast sharply with the background (see Condition 4 of Attachment 1).
- 4. The CUP expires on January 9, 1997, unless a building permit has been issued or a time extension is requested prior to that date (see Code Requirement "Plng 1" of Attachment 1).
- All contractors and subcontractors must have valid business licenses to do business in the City of Costa Mesa. Final inspections will not be granted until all such licenses have been obtained (see Code Requirement "Bldg, 2" of Attachment 1).

Construction Plans

The City's appeal period will end on January 17, 1996. Construction plans can be submitted to the City's Building Department after that date.

Please notify me of the construction schedule to allow for a site inspection prior to City sign-

Final Approval

Please provide a copy of the final sign-off from the City. This will trigger us to notify PBMS

xc: Michael Flynn, PBMS Project Manager (fax: 825-8102)
File: CM-049-19

RECEIVED IN THE JAN 1 1 1996



CITY OF COSTA MESA P.O. BOX 12

NEVEL OPMENT SERVICES DEPARTMENT

January 9, 1996

Ms. Patty Hamilton Pacific Bell 3848 7th Avenue, Room 120 San Diego, CA 92103

RE: MINOR CONDITIONAL USE PERMIT ZA-95-19 ADD SIX (6) ROOF-TOP ANTENNAS 1786 ORANGE AVENUE, COSTA MESA.

Review of the Minor Conditional Use Permit for the above-referenced project has been completed. The application is approved, based on the following findings and subject to the conditions set forth

FINDINGS

- The information presented substantially complies with Section 13-347 of the Costa Mesa Municipal Code in that:

 - The proposed development or use is substantially compatible with developments in the same general area and would not be materially detrimental to other properties within the area. Specifically, the antennas will be attached to, or be of the same height as an existing mechanical screen; they will be small in size and painted to match the screen. Therefore, they will not be readily visible. Granting the Minor Conditional Use Permit will not be materially detrimental to the health, safety and general welfare of the public or otherwise injurious to property or improvements within the immediate neighborhood. Specifically, information in the record indicates that the radiation generated is within the limits established by ANSI/IESE for this type of equipment.
 - equipment.

 c. Granting the Conditional Use Permit will not allow a use, density, or intensity which is not in accordance with the General Plan designation for the property.
- The project has been reviewed for compliance with the California Environmental Quality Act (CEQA), the CEQA Guidelines, and the City environmental procedures, and has been found to be exempt.

77 FAIR DRIVE ZA-95-19 1786 Orange Avenue Page 3

Upon receipt of this letter, your project has been approved, subject to the above listed conditions. A copy of the conceptually approved site plan is enclosed. The decision will become final on January 17, 1996 unless appealed by an affected party or called up for review by a member of the Planning Commission or City Council.

If you have any questions regarding this letter, please feel free to contact Willa Bouwens-Killeen at 754-5153 between 8 a.m. and 12 noon.

Sincerely and William William

Enclosure: Conceptually Approved Site Plan

Engineering/Development Services Fire Protection Analyst Water District

T··Mobile •

PLANS PREPARED BY



- CONSULTING GROUP: -



NO.	- DATE:-	-DESCRIPTION:-	-BY:
0	09/08/14	90% CD'S	HL
1	10/08/14	100% CD'S	HL
2	11/11/14	100% CD'S	DC
3	2/03/15	100% CD'S	GN
4	6/26/15	100% CD'S	FC
5	07/16/15	100% CD'S	JPC
6	08/19/15	100% CD'S	SA
7	09/16/15	100% CD'S	DC
8	09/28/15	100% CD'S	SA
9	10/30/15	100% CD'S	SA

- SITE INFORMATION: -

CM049 LE103

LA02049A

1786 ORANGE AVE., COSTA MESA, CA 92626

- SHEET TITLE: -

- SEAL: -

CONDITIONS OF APPROVAL

SHEET NUMBER: -

					EXISTI	NG ANTE	NNA SCHEDULE		
SECTOR			ANTENNA		ANTENNA RAD	RAD	THE / DOI:	CABLE TYPE	CABLE LENGTH
SECTOR	ANT. TECH.	MODEL	SIZE	AZIMUTH	CENTER	TMA / RRU	CABLE TIPE	CABLE LENGTH	
SECTOR "A"	A1	GSM/UMTS_PCS UMTS_AWS	AIR21 B2A/B4P	56"	0"	42*-8**	(1) TWIN AWS TMA	(4) 7/8" COAX	
SE A2	A2	LTE_AWS	AIR21 B4A/B2P	56"	0*	42"-8"	N/A	(1) HCS 3X6	
SECTOR "B"	В1	GSM/UMTS_PCS UMTS_AWS	AIR21 B2A/B4P	56"	120°	42"-8"	(1) TWIN AWS TMA	(4) 7/8" COAX	55'
SEC	B2	LTE_AWS	AIR21 B4A/B2P	56"	120*	42"-8"	N/A	(1) HCS 3X6	33
SECTOR "C"	C1	GSM/UMTS_PCS UMTS_AWS	AIR21 B2A/B4P	56"	240*	42"-8"	(1) TWIN AWS TMA	(4) 7/8" COAX	70'
SEC	C2	LTE_AWS	AIR21 B4A/B2P	56"	240°	42"-8"	N/A	(1) HCS 3X6	/0

0

(E) BOLLARDS TO REMAIN (TYP.)

ANTENNA SCHEDULE

(E) T-MOBILE EQUIPMENT CABINET— ON (E) CONCRETE SLAB TO REMAIN

(E) T-MOBILE SHEET METAL STEP OVER-COVER TO BE REMOVED

(E) T-MOBILE ABOVE GRADE CARLES-

				PROPOS	SED ANTER	VNA SCH	IEDULE (RFDS VERS	SION 2)		
CEOT	20	ANTENNA			ANTENNA RAD		AD TMA / RRU	CABLE TYPE	CABLE LENGTH	
SECTO	JK	ANT, TECH.	MODEL	SIZE	AZIMUTH	CENTER	THIA / TITO	ONDEE THE ONDEE LES		
,*<	A1	GSM/UMTS_PCS LIMTS_AWS	AIR21 B2A/B4P	56*	0'	42"-8"	(1) TWIN AWS	(4) 7 (0" 0047	(4) 7 (0" 004)	
SECTOR	A2	LTE_AWS	AIR21 B4A/B2P	56	0'	42'-8	N/A	(4) 7/8" COAX (1) HCS 3X6	60'	
SEC	A3	LTE_700	LNX-6515DS-A1M	96.4"	0"	42"-0"	(1) RRUS11B12			
ja	B1	GSM/UMTS_PCS LIMTS_AWS	AIR21 B2A/B4P	56"	120°	42"-8"	(1) TWIN AWS	(4) 7/8" COAX (1) HCS 3X6 55'		
DR.	82	LTE_AWS	AIR21 B4A/B2P	56"	120°	42"-8"	N/A		55'	
SECTOR	В3	LTE_700	LNX-6515DS-A1M	96,4"	120"	42"-0"	(1) RRUS11B12			
, ,	C1	GSM/UMTS_PCS LIMTS_AWS	AIR21 B2A/B4P	56"	240'	42"-8"	(1) TWIN AWS	(4) 7 (9" 004)		
SECTOR	C2	LTE_AWS	AIR21 B4A/B2P	56"	240*	42"-8"	N/A	(4) 7/8" COAX (1) HCS 3X6	70'	
SEC	C3	LTE_700	LNX-6515DS-A1M	96.4	240*	42"-0"	(1) RRUS11812			

T·Mobile

- PLANS PREPARED BY:



6455 Rancho Pkwy South, Lake Forest, C.1 92630

- CONSULTING GROUP:



1

SECTOR 'A'

0°

SCALE: "=30'-0" 16150 Scientific Way Irvine, CA 92618 Phone: (919) 336-1550 Fax: (949) 336-6665

NO. —	09/08/14	PDESCRIPTION: 90% CD'S	BY: HL
1	10/08/14	100% CD'S	HL
2	11/11/14	100% CD'S	DC
3	2/03/15	100% CD'S	GN
4	6/26/15	100% CD'S	FC
5	07/16/15	100% CD'S	JPC
6	08/19/15	100% CD'S	SA
7	09/16/15	100% CD'S	DC
8	09/28/15	100% CD'S	SA
9	10/30/15	100% CD'S	SA

- SITE INFORMATION: -

CM049 LE103

LA02049A

1786 ORANGE AVE., COSTA MESA, CA 92626

(C) BALONG

(C) BALONG

(C) FAM HEE PROVISION
THE PROVISION
TO BE THROUGH AND ANTENNAS (PROVIDED AREA OF WORK)

(C) BALONG

(C


SHEET TITLE: -


SITE PLAN, (E) EQUIPMENT LAYOUT & ANTENNA SCHEDULE

- SHEET NUMBER:

2

A-1

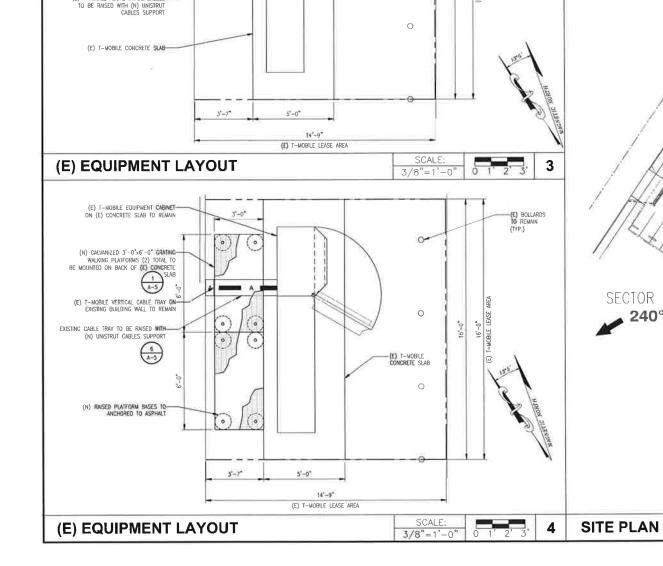

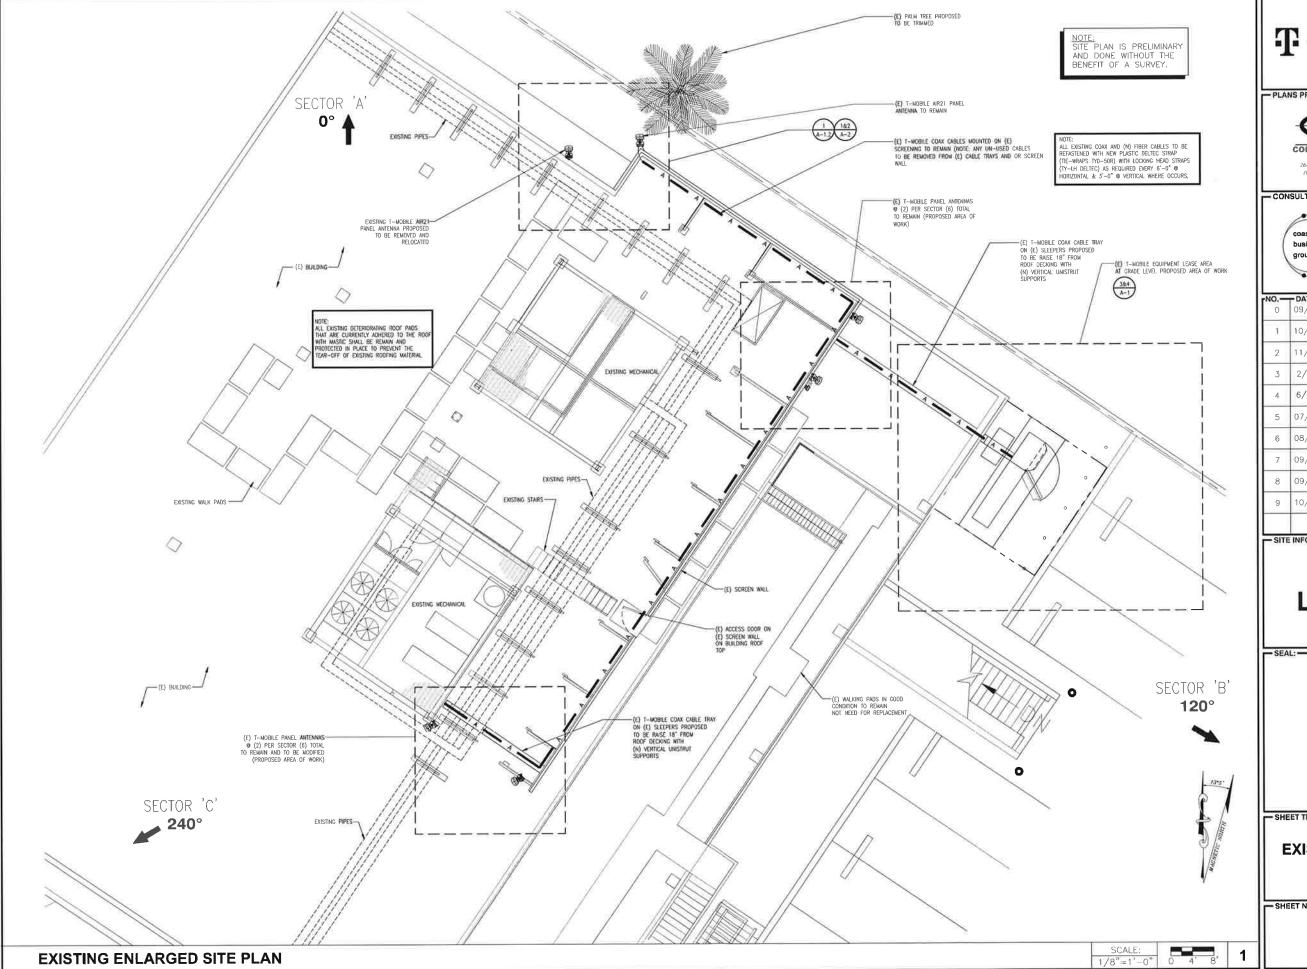

T··Mobile·



CONNELL DESIGN GROUP, LLC
CONSULTING CHI'LL ENGINEERS
26455 Rancho Phyty South, Lake Forest. C.1 92630
(949) 753-8807 OFFICE - (949) 753-8833 FAX



NO.	- DATE:-	-DESCRIPTION:	- BY:
0	09/08/14	90% CD'S	HL
1	10/08/14	100% CD'S	HL
2	11/11/14	100% CD'S	DC
3	2/03/15	100% CD'S	GN
4	6/26/15	100% CD'S	FC
5	07/16/15	100% CD'S	JPC
6	08/19/15	100% CD'S	SA
7	09/16/15	100% CD'S	DC
8	09/28/15	100% CD'S	SA
9	10/30/15	100% CD'S	SA

- SITE INFORMATION: -

CM049 LE103

LA02049A


1786 ORANGE AVE., COSTA MESA, CA 92626

- SHEET TITLE: -

EXISTING ENLARGED SITE PLAN

- SHEET NUMBER: -

A-1.1

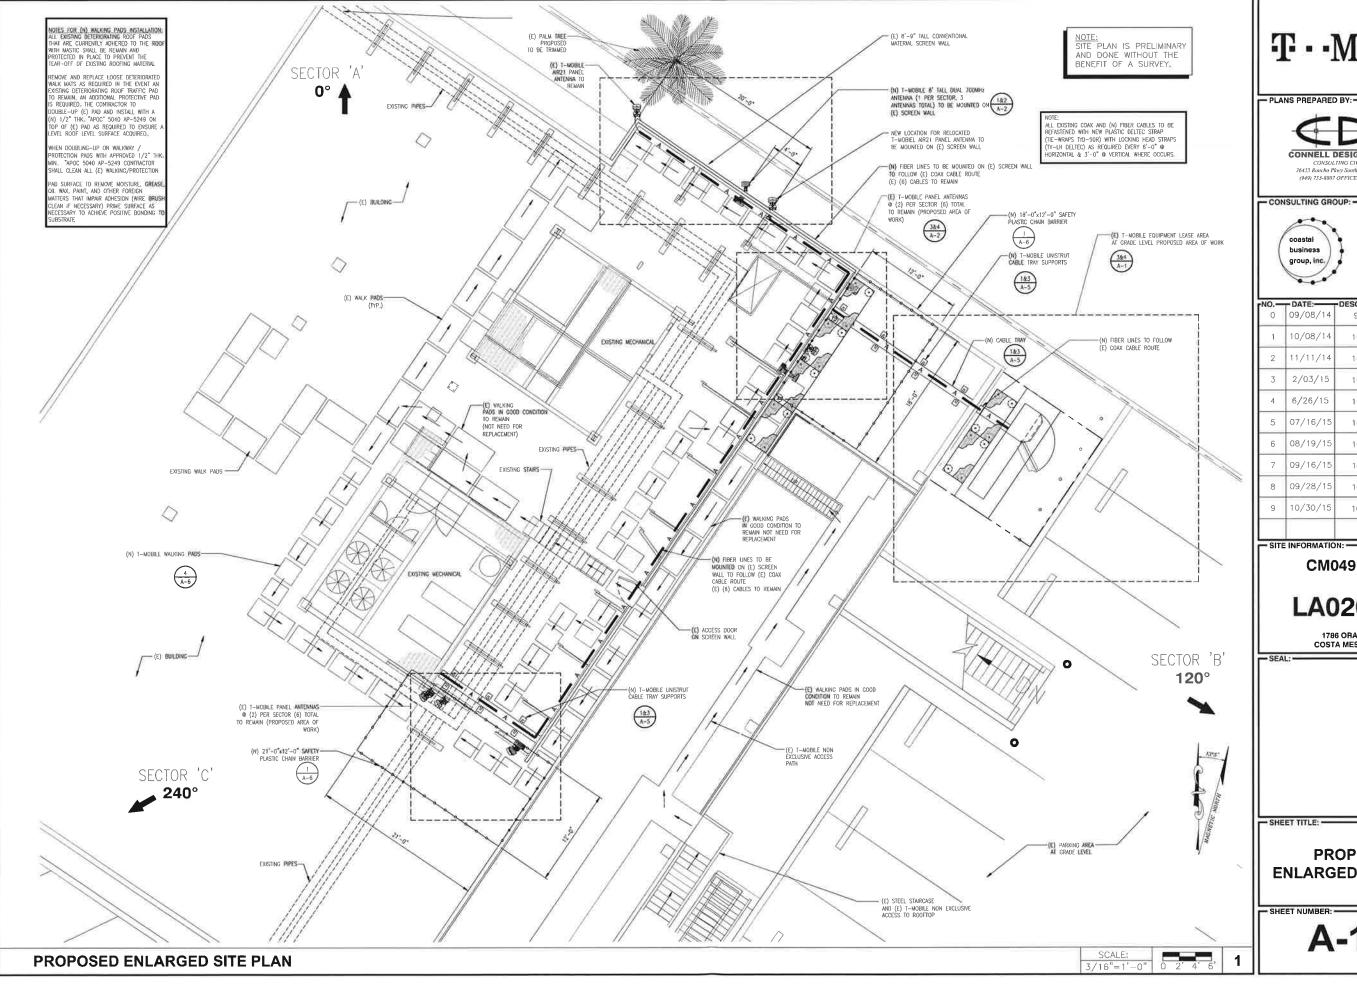

T··Mobile •



CONSULTING CIVIL ENGINEERS 26455 Rancho Pkwy South, Luke Forest, C.t 92630 (949) 753-8807 OFFICE - (949) 753-8833 FAX

16150 Scientific Way Irvine, CA 92618 Phone: (949) 336-1550 Fax: (949) 336-6665

	0	09/08/14	90% CD'S	HL
	1	10/08/14	100% CD'S	HL
	2	11/11/14	100% CD'S	DC
	3	2/03/15	100% CD'S	GN
	4	6/26/15	100% CD'S	FC
110	5	07/16/15	100% CD'S	JPC
	6	08/19/15	100% CD'S	SA
	7	09/16/15	100% CD'S	DC
	8	09/28/15	100% CD'S	SA
	9	10/30/15	100% CD'S	SA


CM049 LE103


LA02049A


1786 ORANGE AVE., COSTA MESA, CA 92626


PROPOSED ENLARGED SITE PLAN


A-1.2

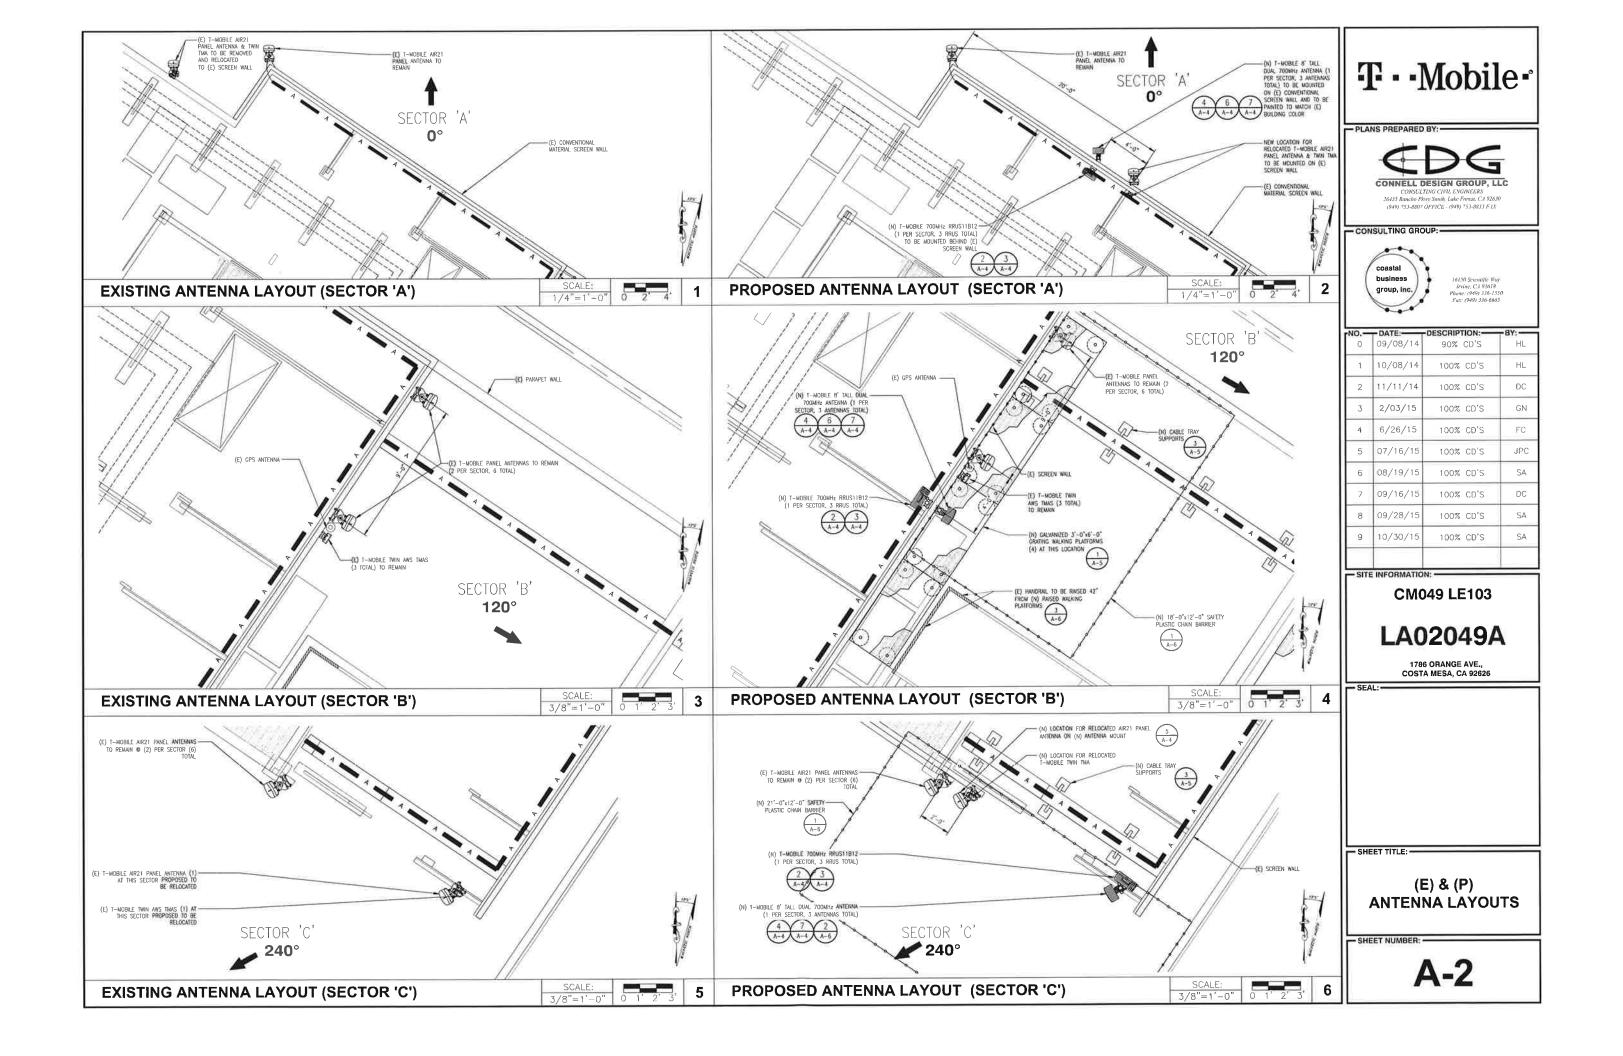

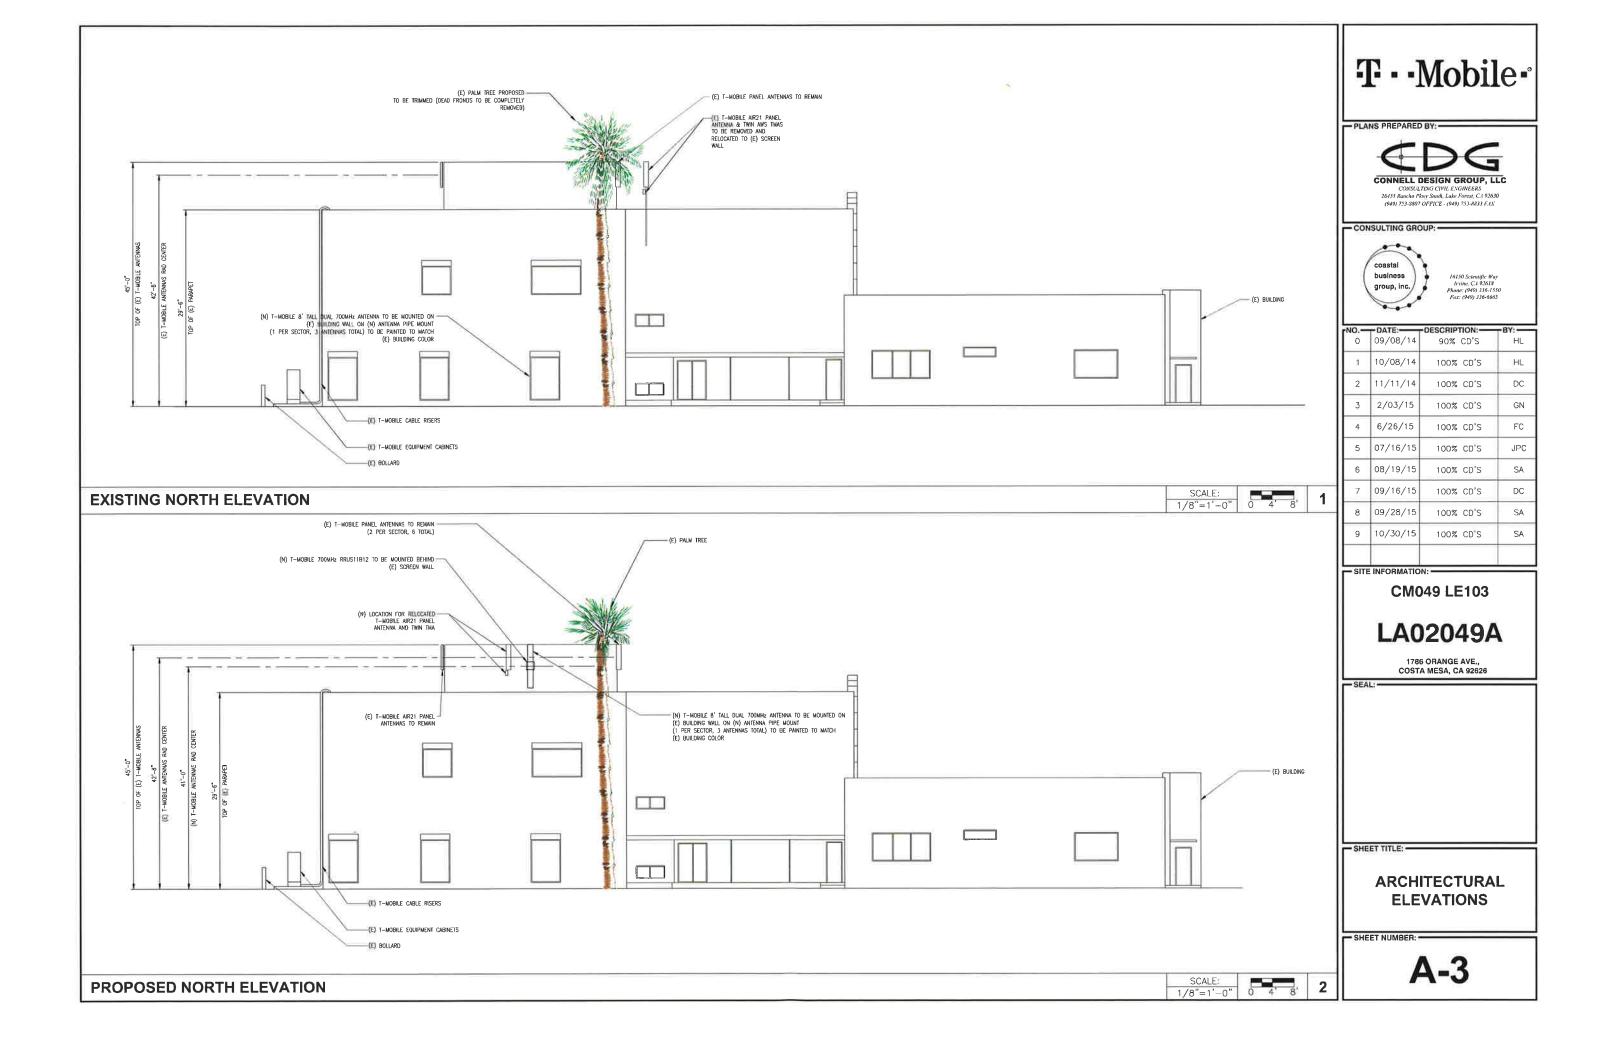

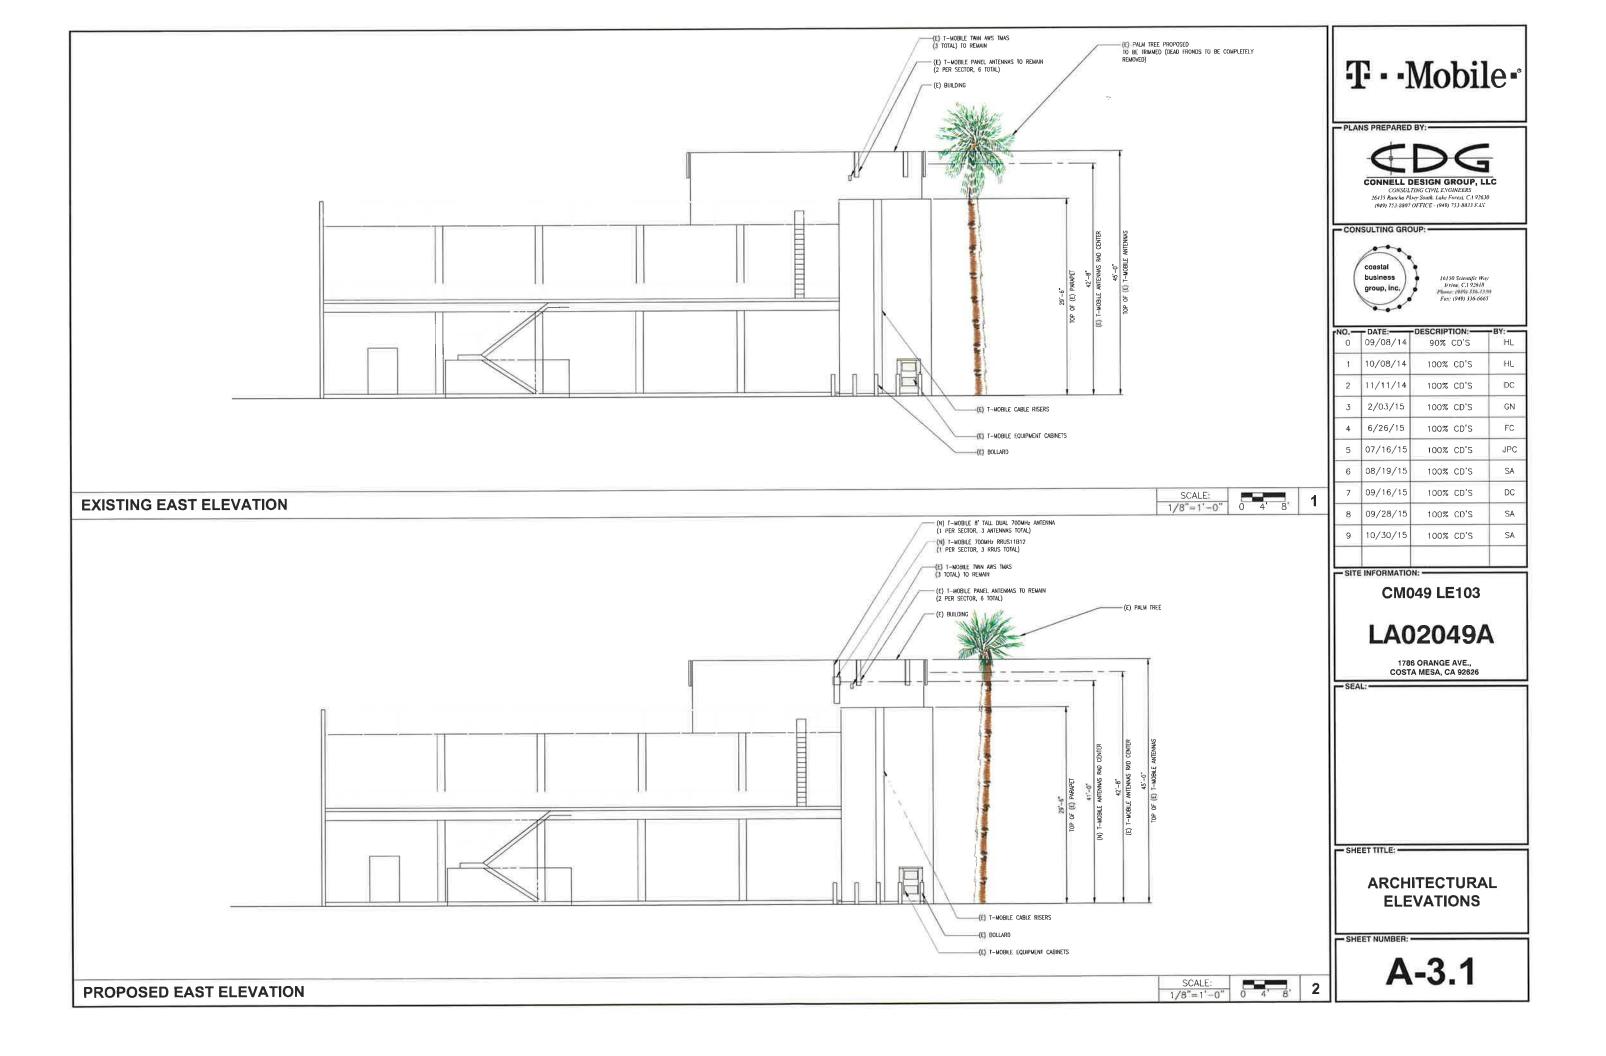

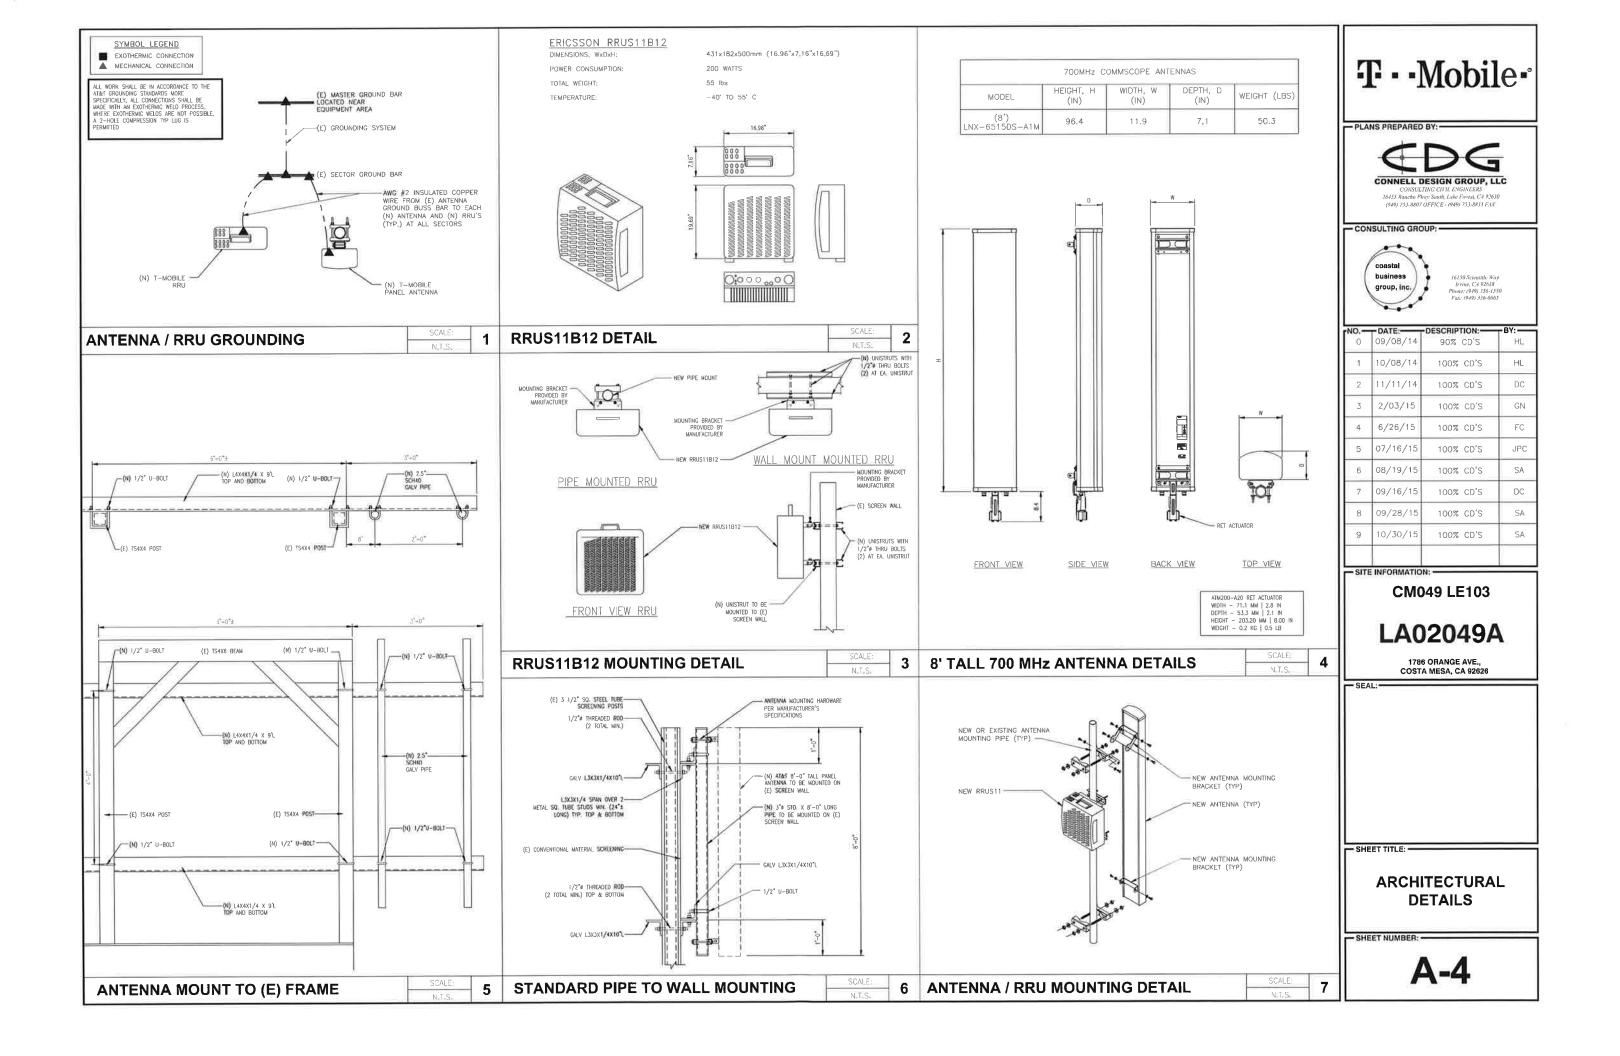

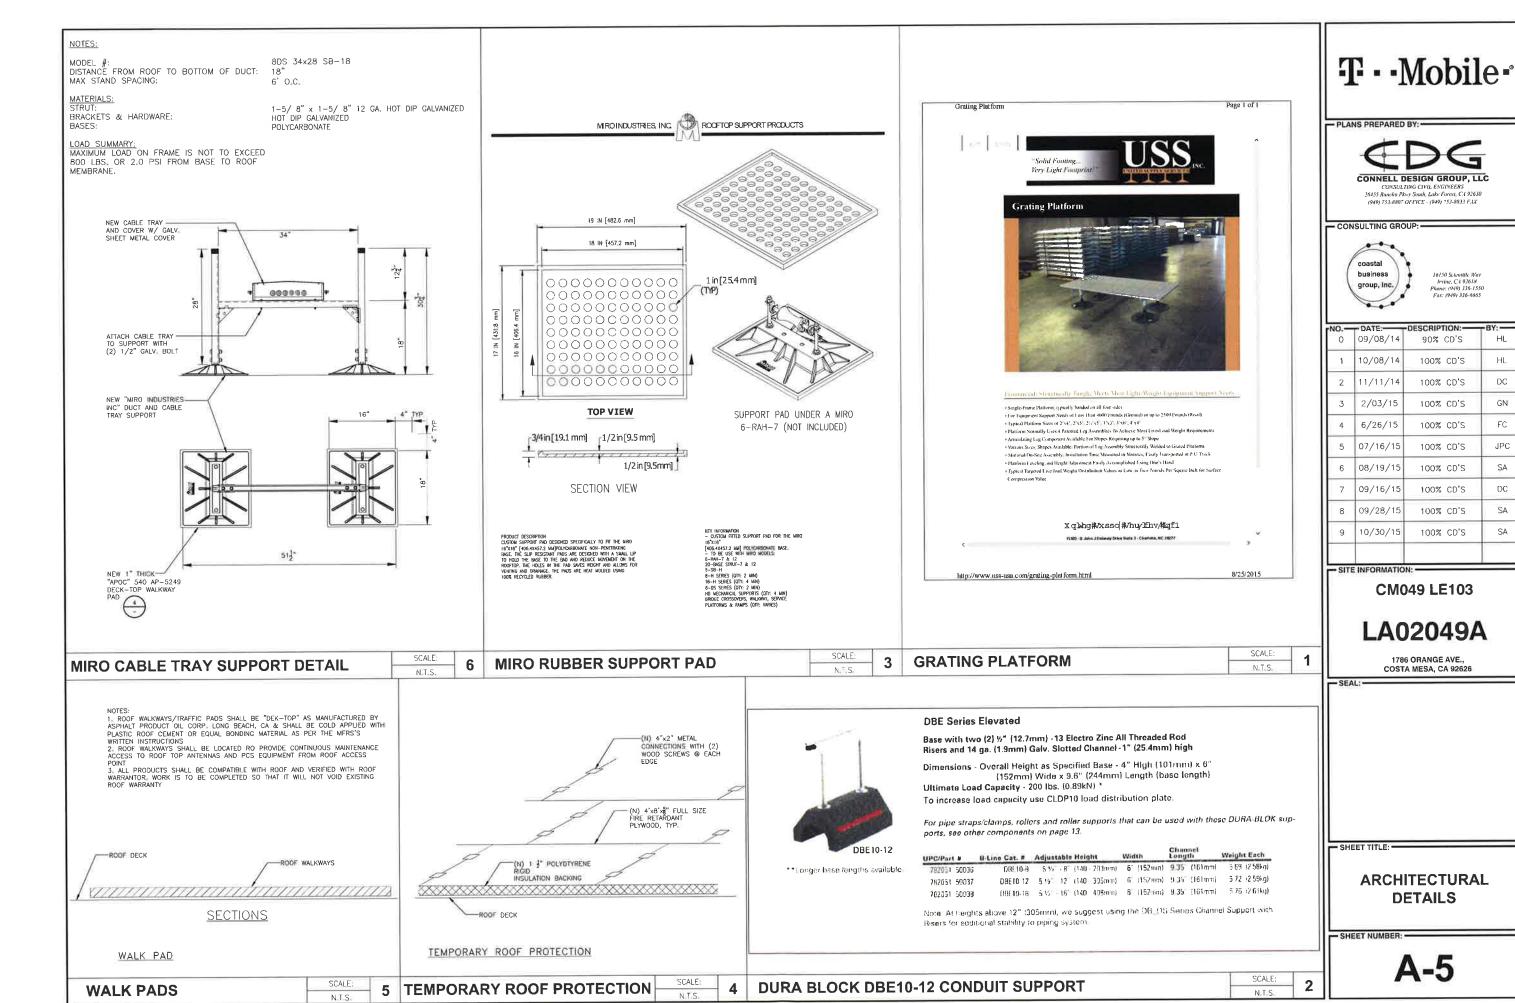

HL

HL

DC

FC


JPC

SA


DC

SA

SA

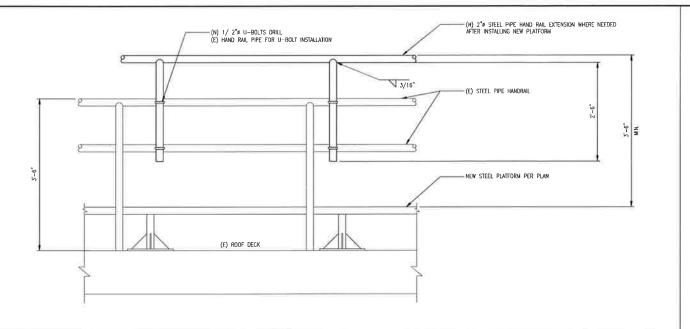

APOC k 5040 - Dek-Top R Walkway Pads

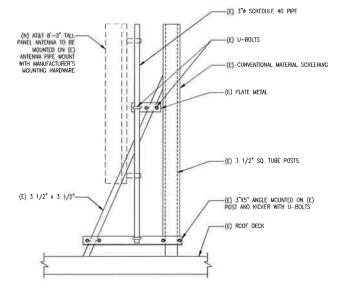

T··Mobile





16150 Scientific Way Irvine, C.4 92618 Plant (949) 135-1550 Fax (949) 336-6665

	0	09/08/14	90% CD'S	HL
2	1	10/08/14	100% CD'S	HL
	2	11/11/14	100% CD'S	DC
	3	2/03/15	100% CD'S	GN
	4	6/26/15	100% CD'S	FC
200	5	07/16/15	100% CD'S	JPC
1	6	08/19/15	100% CD'S	SA
	7	09/16/15	100% CD'S	DC
	8	09/28/15	100% CD'S	SA
	9	10/30/15	100% CD'S	SA

- SITE INFORMATION: -

- SEAL: -

CM049 LE103

COSTA MESA, CA 92626

- SHEET TITLE: -

DETAILS

SHEET NUMBER: -

SCALE:

N.T.S.

A-6

SCALE: SCALE: HANDRAIL EXTENSION ANTENNA MOUNTING DETAIL 3 NTS N.T.S



COMPLIANCE: Exceeds performance requirements of ASTM D 517 and ASTM £ 108

APOC

PRECAUTIONE: DEK-TOP by iself is not intended to provide a finished fool memberary or intended as a substitution for reclining of to provide any structural support. DEK-TOP is not hypocray recommended to pation become sor placa decisioners from formation legs and light metals could week away the outlier.

Demensions Weight Surface Color
1/2 3 X 4 55 tos separat When commit grandes 3 X 4 70 lbs (popos) White ceramic granules
3 X 4 85 lbs (approx) White ceramic granules
Note: Other granule colors available upon request.

MODERNY MODIOS MOSS ESPECIALISMES MICHESTRAN HAS MANY MEN PRODUCTS 4570 ARQL & 1940 Day. Right Applicate Pads have a rough rich and rough rich and rough rich. CAN TUR active entered of options, insulating factors and resident factors for day as compared and resident control of control or control options. The resident factors for the resident factors factors factors for the resident factors factors for the resident 137 4 × 8 100 5m 45 to 15 15 15 16 16 15 to 16 NA STREET, SHEET, 14 5 4 7 40.5791 COST DATE space distribution in an inchessor. ROOFING SYSTEMS - COATINGS & SEALANTS HOMEOWNERS - WATERPROOFING

http://www.apoc.com/finedetails/aspx?id=32?

YELLOW PLASTIC CHAIN TO BE THE EYE BOLT TO BE MOUNTED TO (N) EYE BOLT ON PAID WITH NUT INSIDE AND OUTSIDE -3[™] PVC CAP 8.75"x11.25 MIRO SUPPORT -7 1/2" -3's PVC PIPE 8"x8"x12" CONCRETE WITH 8.75"x11.25 MIRO SUPPORT -

ELEVATION

©2008 Gardner Asphalt Corporation Manufactured by / Fabricado por Gardner Asphalt Corporation PO Box 5449 Timeza, FL 33675

Gardner Asphalt Corporation • P.O. Box 5449 • Tampa, Florida 33675-5449

Phone: (813) 248-2101 • Fax (813) 248-6768 • www.apoc.com

SCALE:

active concept models does not the

3"Ø PVC BARRIER POST DETAIL

ROOF PROTECTION MAT DETAILS

IN RESPONSE FROM SUBMITTED CDS WITH REVISION MARKED DELTA 5, DATED 07/16/15 AND HAVE INCLUDED ARCHITECTURAL /STRUCTURAL PLANS REVIEW COMMENTS ARE OUTLINED BELOW:

I WOULD LIKE TO SHARE PHOTOS AND AS-BUILT DRAWINGS INFORMATION FOR EASY REFERENCES. PLEASE FOLLOW THE LINK BELOW TO DOWNLOAD :

HTTPS://ONEDRIVE.LIVE.COM/REDIR?RESID=CF334678997CA4F0H024&AUTHKEY=\APSQSCPUQUZVERC&ITHNT=FOLDER%2CJPG

HTTPS://ONEDRIVE.LIVE.COM/REDIRPRESID=CF334678997CA4F0!1999&AUTHKEY=:AASA=WMAREWQYS&ITHINT=FOLDER%2CPDF

A PEER REVIEW SITE WALK WERE CATHERED TO HAVE "T-MOBILE WIRELESS" DESIGN TEAM TO PERFORM AN ADEQUATE AND ACCURATE INVESTIGATION OF EXISTING FIELD CONDITIONS AND SHALL BE ATTENTIVELY TO FOLLOW THE DISCUSSED/ISSUED REQUIREMENTS OF AT&T GUIDELINES AND RECOMMENDATION, IN ORDER FOR THE PROCESS TO RUN SMOOTHLY AND THEIR DRAWINGS TO BE APPROVED.

2. ON SHEET NO. A-1, SITE PLAN. ON DETAIL NO. 2/A-1, (E) EQUIPMENT LAYOUT

SHOUTE No. 27/2-1, (2) CARRIENT ENTOY.
SHOU ON PLAN AND CALL—OUT (E) CABLINGS/CONDUIT RUN SUPPORTS MOUNTED ON PVC LAID SLEEPERS TO BE.
REMOVED AND REPLACED, SPECIFY "UNISTRUP" THE ATACT APPROVED SUPPORTS SHALL BE USED FOR EXTERIOR. WALL/GROUND LEVEL ON A AC PAVING AND CONCRETE PAD.

 SHOW ON PLAN: CALL OUT TO REMOVE STEP OVER SHEET METAL COVER AND PROVIDE A LEVEL CRATING PLATFORM
SUFFACES AND SPECITY APPROVED. MANUFACTURERS USS PREFAB SIEP—CROSSOVER ADJUSTABLE PLATFORM DETAIL.
UNITED SUPPLY SERVICES USS, INC. HTTP://WWW.USS-UJS.COM/WEIGHT-OISPESHIG-BASE.HTML., TO PERMIT SAFE. PASSAGE AND ACCESSIBLE LEVEL LANDING (48" MIN. WIDTH) SHALL BE PROVIDED OVER ITS FULL LENGTH FROM THE LEVEL OF (E) CABINET EQUIPMENT BASE SURFACE

SHEET A-1 MAS BEEN REVISED TO REFLECT THE REMOVAL OF EXISTING PVC AND EXISTING STEP OVER SHEET METAL COVER TWO DETAILS HAVE BEEN ADDED TO SHOW EXISTING CONDITION AND PROPOSED CONDITION.

SHOW ON PLAN TO REVISED AND APPROXIMATELY SHOW THE BORDER OF HIGHLIGHT ON PLAN TO REFER SHEET NO. A-1.1 (EXISTING) AND A-1.2 (PROPOSED) :

SHEET A-1.1 has been revised to show only existing condition and New Sheet A-1.2 has been added to the set for proposed items to be installed.

. ON THE REVISE SHEET NO. A-1.1 (EXISTING), ENLARGED PARTIAL ROOF/SITE PLAN AND SEPARATELY CALL-OUT FOR EXISTING AND PROPOSED AREA OF WORK.

SHEET A-1.1 AND A-1.2 HAVE BEEN REVISED TO REFLECT EXISTING AND PROPOSED ITEMS

SHOW ON PLAN: SPECIFICALLY CALL—OUT PEER REVIEW SITE WALK RECOMMENDATION BASED ON THE FIELD CONDITION (REFER TO LINK PHOTOS), THE PROJECT DESIGNER "T-MOBILE WIRELSS" SHALL CLEARLY DEFINE THE (F) CONDITION AND CALL—OUT THE PROPOSED EXTENT SCOPE OF WORK TO BE REJOYED, REJOCATED, TO BE MODIFIED AND ITS RELATED AFFECTED AREA OF CONSTRUCTION TO HAVE AN ACCURATE BASED PLAN PRIOR TO MYOSED OF ANY NEW SCOPE OF WORK TO AVOID ANY DISCREPANCY."

PLANS HAVE BEEN REVISED TO REFLECT AND IDENTIFY EXISTING AND PROPOSED CONDITIONS

HIGHLIGHT EXISTING AREA OF WORK WITH REFERENCE CALL-OUT ON DETAIL NOS, 1,3 &5/A-2 AT EACH EXISTING ANTENNA SECTORS AND/OR EQUIPMENT LAYOUT PLAN,

SHEET A-2 HAS BEEN REVISED TO CLEARLY IDENTIFY THE MODIFICATIONS FOR EACH SECTOR ON EXISTING AND PROPOSED DETAILS FOR ALL THREE SECTORS

. THE PROJECT DESIGNER SHALL COMPLETELY IDENTIFY T-MOBILE WIRELESS' ALL CABLING RUN TO (E) ROUTE FROM LEASE AREA OF GROUND COUPMENT CUBIET UP TO (E) PENHOUSE ROOTED AND TO UPPER LEVEL MCCHANCAL STEEL RASED PLATFORM WHERE UNDER THE (E) UNCOVERED CABLE TRAY COAX RUN AND VERTICAL SUPPORT ROOFTOP WILL BE REMOVE/REPLACE ON (E) CABLE TRAY WITH APPROVED VERTICAL SUPPORTS PER AT&T CRITERIA

NEW CABLE TRAY SUPPORTS HAVE BEEN ADDED TO DETAILS 4 AND 6 ON SHEET A-2 FOR THE INSTALLATION OF (N) RAISED CABLE TRAY SUPPORTS (18" ABOVE ROOF DECK)

THE PROJECT DESIGNER SHALL SHOW EXACT LOCATIONS "T-MOBILE WIRELESS" (E) COAX CABLE ROUTED FROM ROOFTOP EQUIPMENT CABINET TO (E) ANTENNAS LOCATION.

CABLE LINES ARE CLEARLY IDENTIFY ON SHEET A-1,2 FROM (E) EQUIPMENT LEASE AREA TO ROOFTOP

WHERE THE COAX CABLES RUN ARE PIGCY BACK AND/OR MOUNTED/ATTACHED ON (E) AT&T INFRASTRUCTURE SUCH AS HVAC STEEL RAISED PLATFORM/PAD AND COOLING PIPE OR CONDUIT SUPPORT WILL BE REMOVE AND BE SEPARATELY PLACE ON CABLE TRAY WITH VERTICAL SUPPORTS.

EXISTING COAX CABLES DON'T HAVE POWER CONDUIT FROM (E) EQUIPMENT LEASE AREA TO EACH ANTENNA SECTOR ON ROOFTOP, ONLY COAX IS UTILIZED FROM EQUIPMENT TO ANTENNAS, NO POWER CONDUIT IS RUN UP TO THE ROOF.

ADD NOTE ON PLAN: ALL EXISTING DETERIORATING ROOF PADS THAT ARE CURRENTLY ADHERED TO THE ROOF WITH MASTIC SHALL BE REMAIN AND PROTECTED IN PLACE TO PREVENT THE TEAR-OFF OF EXISTING ROOFING

A PROVISIONS TO CALL-OUT COMPLETELY REMOVE DEAD AND ABANDONED CABLING TO BE COMPLETELY REMOVE AS REQUIRED.

NOTE HAS BEEN ADDED TO SHEET A-1,2 FOR INSTALLATION AND REPLACEMENT OF WALK PADS

SHOW ON PLAN: THE EXACT LOCATION AND CALL-OUT THE (E) WALKMATS TO ENSURE COVERAGE OF PATH OF TRAVEL FROM THE (E) STAIRWAY ACCESS POINT OF LOWER ROOFTOP UP TO PENTHOUSE ROOFTOP AND UP TO UPPER LEVEL WHERE WECHANICAL SCREEN WALL DOOR ACCESS POINT AND TO THE LOCATIONS WHERE THE ATTENNAS AREA OF WORK REQUIRING PREQUENT MAINTENANCE. THE PEER REVIEW SITE WALK HAS DETERMINED WITH TRAFFIC PATTERNS CAN BE HELPFUL IN REDUCING THE SUBJECTIVITY OF DECISIONS FOR LOCATION (N) WALKMATS OR THE POTENTIAL NEED TO PROVIDE (N) STEP CROSS OVER ON (E) ELEVATED WALKWAYS AND/OR (N) RAISED CABLE TRAY EXTREME ROOF-TOP TRAFFIC REQUIRES EXTRAORDINARY PROTECTION TO PROVIDE NORMAL ROOF SERVICE LIFE.

ON SHEET A-1.2 HAS BEEN ADDED A PATH OF TRAVEL FROM (E) STEEL STAIRCASE TO ROOFTOP AT EACH ANTENNA

3. ON ADDED SHEET DETAIL NO, —/A—1.2, ENLARGED PARTIAL ROOF PLAN (PROPOSED). SHOW ON RENSED ROOF PLAN: SPECFICALLY CALL—OUT TO ADD (N) WALKWATS TO ENSURE COVERAGE OF PATH OF TRAVEL FROM ROOFFOP STARWAY (E) ACCESS POINT OF DETAIL ROOFFOP ROOFFOP STARWAY (E) ACCESS POINT UP TO AROUND (0) FRONT AND BEHIND) OF ACRES AND TOWARDS TO MCCHANICAL SCREEN WALL DOOR ACCESS POINT UP TO AROUND (0) FRONT AND BEHIND) OF ALTOHOLD ROOFFOR AND MORTHAND SECTION AND RISKS AS REQUIRED WHERE WORK AND MAINTENANCE WOULD DONE. SPECIFY: I' MINK THK: APOC: 5040 AP—5249 DEK—TOP WALKWAY PADS WITH FULL BED OF MASTIC ADFERED AT UNDERSIDE OF MASS /SEC ATTACHED (LIT CATALANCE).

ON SHEET A-1.2 HAS BEEN ADDED A PATH OF TRAVEL FROM (E) STEEL STAIRCASE TO ROOFTOP AT EACH ANTENNA

HIGHLIGHT PROPOSED AREA OF WORK WITH REFERENCE CALL-DUT ON SHEET NOS 2, 4&6/A-2 AT EACH PROPOSED ANTENNA SECTORS AND/OR EQUIPMENT LAYOUT PLAN.

DETAILS FOR EXISTING AND PROPOSED ANTENNA LAYOUTS HAVE BEEN REVISED TO REFLECT EXISTING AND PROPOSED

PROPOSED AND (E) CABLE RUN MOUNTED ON (N) CABLE TRAY, ADD AND SHOW ON PLAN THE EXACT LOCATION AND QUANTITIES OF (N) VERTICAL SUPPORT IS NOT TO EXCEED 6 FOOT ON CENTERS ON PLAN AND/OR DETAIL.

NEW CABLE TRAY SUPPORTS ARE CLEARLY IDENTIFY ON DETAILS 4 AND 6 SHEET A-2

HOW AND CLEARLY DEFINE THE (N) SCOPE OF WORK OF ROOFING CABLING ANTENNA AREAS ANY HYBRIFLEX TO BE RUN WITHIN (N) INSTALLED CABLE TRAY MOUNTED TO ROOFTOP

NEW HYBRIFLEX CABLES ARE CALL OUT ON SHEET A-1,2 TO BE INSTALLED TO FOLLOW (E) COAX CABLES ROUTE

SHOW (N) & (E) COAX EXACT QUANTITIES AND SPECIFY THE MAXIMUM NUMBER OF THE CABLE TO BE PLACED IN THE (N) COVERED CABLE TRAY AT ROOFTOP/EXTERIOR WALL

(E) CABLE COUNTS IS CALLED OUT ON SHEET A-1.2

ALL (N) CABLE TRAYS AND SHOULD BE RUN PARALLEL WITH PERIMETER INSIDE PARAPET BUILDING WALLS (AVOID DIAGONAL RUNS), AND SHOULD BE POSITIONED NO CLOSER THAN 36 INCHES ARE REQUIRED AT CERTAIN EXISTING ROOFTOP EQUIPMENT LOCATIONS FOR MAINTENANCE PURPOSES.

NO NEW CARLE TRAYS ARE PROPOSED. T-MOBILE IS ONLY MODIFYING EXISTING CABLE TRAYS / RAISING THEM 18" FROM (E) ROOFDECK AND CABLE TRAYS ARE MORE THAN 36" FROM PARAPET OR (E) EQUIPMENT

PROVIDE AND CALL OUT ALL CABLING ON RAISED CABLE TRAY AND SHALL BE COVER WITH METAL GALVANIZED SHEET LID.

(E) CABLE TRAYS HAVE CALVANIZED LIDS T-MOBILE WILL ONLY RAISE EXISTING CABLE TRAYS 18" FROM ROOFDECK WITH (N) CABLE TRAY SUPPORTS

. ALL (E) COAX AND (N) FIBER CABLES TO BE REFASTENED WITH NEW PLASTIC DELTEC STRAP (TIE-WRAPS TYD-SOR) WITH LOCKING HEAD STRAPS (TY-LH DELTEC) AS REQUIRED EVERY 6"-0"® HORIZONTAL & 3"-0" ® VERTICAL.

NOTE HAS BEEN ADDED TO SHEET A-1.2 TO ADD CABLE TIES ON (E) AND NEW CABLES

THE PEER REVIEW SITE WALK HAS BEEN DETERMINED WITH TRAFFIC PATTERNS CAN BE HELPFUL IN THE PEER REVIEW SITE WALK HAS BEEN DETERMINED WITH HAPPET PATIENTS CAN BE HELPYLL IN REDUCING THE SUBJECTION TO DECISIONS FOR LOCATION (N) WALMARS, REMOVE AND REPUACE LOOSE DETERMINED WALKARTS AS REQUIRED, IN THE EVENT AN EXISTING DETERMINED FOR TRAFFIC PAD TO REWAIN, AN ADDITIONAL PROTECTION FOR DIS REQUIRED, IN THE EVENT AN EXISTING DETERMINED FOR TRAFFIC PAD TO REWAIN, AN ADDITIONAL PROTECTION FOR DISCOVERY OF SOME PAGE AND INTO FOR CONTRAFFIC PAD INSTALL WITH A (N) % THIS, MINI-PAPOR'S SOAD AP-5249 ON TOP OF (E) PAD AS REQUIRED TO ENSURE A LEVEL ROOF LEVEL SURFACE ACQUIRED, WHEN DIBBURLAND ON WALKARY, PROTECTION PAD SURFACE TO REMOVE MOISTURE, CREASE, OIL WAX, PAINT, AND OTHER FOREIGN ALL (E) WALKING/PROTECTION PAD SURFACE TO REMOVE MOISTURE, CREASE, OIL WAX, PAINT, AND OTHER FOREIGN MATTERS THAT IMPAIR ADHESION (WIRE-BRUSH CLEAN IF NECESSARY). PRIME SURFACE AS NECESSARY TO ACHIEVE POSITIVE

NOTE HAS BEEN ADDED TO SHEET A-1,2 FOR INSTALLATION AND OR REPLACEMENT OF WALKING PADS

ON DETAIL NO. 4/A-2, PROPOSED ANTENNA LYYOUT (SECTOR B) THE POTENTIAL OF RISK SAFETY ISSUES NEEDS TO ADDRESS FOR ACCESSIBILITY SAFETY ROUTE OF TRAVEL TOWARDS PENTHOUSE ROOFTOP AREAS, PROVIDE AN ADJUSTABLE LEVEL GRATING PLATFORM SUFFACES AND SPECIFY APPROVED MAINTACTURER'S USS PREFAB STEP—CROSSOVER ADJUSTABLE PLATFORM DETAIL: UNITED SUPPLY SERVICES USS, INC.

HTTP://WWW.USS_USA.COU/WEIGHT-USSERSONG-BOSE HINL. USE RECOMPRINTO USS PART NO. SIA144, STAND SUPPORT WITH WIRD SUPPORT PADS ROOF PROTECTION, THE NEW LEVEL LANDING (48 MIN, WIDTH) SHALL BE PARALLEL AND CLOSE TO (5) GUARDRAIL AND OVER ITS FULL LENGTH FROM THE LEVEL AT THE END OF EACH (5) PIPING WHERE OCCURS (SEE PIC #9263) MODIEY AND REWORK (F) ADJACENT GUARDRAIL TO SUCH EXTENSION SHALL NOT BE LESS THAN 42' HIGH FROM TOP OF (N) GRATING PLATFORM AND SHALL BE PROVIDED FULL LENGTH OF REQUIRED ELEVATED WALKWAYS.

FOUR GALVANIZED 3'-0"x6'-0" GRATING WALKING PLATFORMS ARE CLEARLY IDENTIFY TO BE ADDED ON DETAIL 4 A-2

SHOW ON PLAN: IDENTIFYING WHERE TRANSITION FROM PENTHOUSE ROOFTOP TO EXTERIOR WALL FOR THE (E) & (N) CABLINGS RUN SUPPORT MOUNTED ON PYC LAID SLEPPERS ON WALKING PADS TO BE FEMOVED AND REPLACED. PROVIDE (N) CABLE TRAY AND ATTACHED TO RECOMMENDED OURA-BLOK B-LINE CAT. | DIBBJO, HIREE (3) BASES, TOTAL OF (2) LOCATIONS WITH REQUIRED APOC ROOF PROTECTION DIRECTLY LAID TO LOWER ROOF LEVEL. SPECIFICALLY APPLIED TO WHERE AREAS NEED TO BE ACCESS.

NEW CABLE TRAY SUPPORT DETAIL HAS BEEN ADDED TO DETAIL 6 / A-5

4. ON DETAIL PROVIDED ON SHEET A-4 & A-5, ALL SECTORS OF ANTENNA MOUNT TO (E) FRAME. SHOW ON PLANS & EACH SECTORS TO CLEARLY AND ACCURATELY REFLECT THE ACTUAL SITE CONDITION. THE ANTENNA SHALL BE DEFINE TO THE ACTUAL TO THE ACCURACY OF DESIGN AND DETAIL TO MOUNT TO ACTUAL (E) CONDITION OF SCREEN WALL AND ITS ASSOCIATED STRUCTURAL STEEL BRACING TO FACILITATE FOR CONSTRUCTION CLARITY PURPOSES.

DETAIL 5 / A-4 SHOWS NEW ANTENNA PIPE MOUNT FOR SECTOR "C"

SHOW THE EXACT LOCATION OF (E) ANTENNA LAYOUT ON PLAN FOR CLARITY, THE PROJECT DESIGNER SHALL VERIFY THE (E) FIELD CONDITION AND/OR PEER REVIEW SITE SHARED PHOTOS TO HAVE AN ACCURATE BASED PLAN PRIOR TO IMPOSED OF PROPOSE (N) SCOPE OF WORK TO AVOID ANY DISCREPANCIES.

DETAILS 1 THRU 6 ON SHEET A-2 SHOW EXISTING AND PROPOSED ANTENNA LAYOUTS

- Provide a full high section of the antenna supporting pole and connection details to facilitate the installation of antenna and ${\sf RRUS}_{\circ}$

DETAIL 6 / A-4 SHOWS THE INSTALLATION OF (N) PIPE FOR SECTOR "A"

5. ON DETAIL NO. 2/A-5, CABLE TRAY SUPPORT FRAME, REVISE AND PROVIDE APPROVED (N) MIRO CABLE TRAY SUPPORT DETAIL (SEE ATTACHED CUT SHEET)
A), SHOW VERTICAL DIMENSION 18' MIN. AND MAX. STAND SPACING OF CABLE TRAY SUPPORT INSTALLATION:
18' MIN. CLEARANCE ABOVE THE ROOT TO THE BOTTOM OF HORIZONTAL MEMBER SUPPORT.
MIRO STAND SPACING IS NOT EXCEED 6 FOOT ON CENTERS.

B), PROVIDE SLIP RESISTANT ROOFTOP MIRO SUPPORT PAD: 16" X 18" RUBBER SUPPORT PAD (SEE ATTACHED

DETAILS 3 AND 8 HAVE BEEN REVISED TO COMPLY WITH THE REQUIREMENT OF INSTALLATION FOR NEW CABLE TRAY

6. PLEASE REFER TO ATTACHED STRUCTURAL REVIEW COMMENTS, DATED AUGUST 12, 2015

1. CREATE ELECTRICAL GENERAL NOTES AND INCLUDE THE FOLLOWING NOTE:

a. ALL ABANDONED AND UNUSED CARRIERS AC/DC, DATA, FIBER, COAXIAL CABLING AND SUPPORTS SHALL BE COMPLETELY REMOVED AS REQUIRED. ALL MODIFICATIONS TO THE ELECTRICAL DISTRIBUTION PANELS SHALL BE LABELED AS REQUIRED.

ELECTRICAL COMMENTS NOTE WAS ADDED TO SHEET T-2

2. REVISE THE CROUNDING DETAL TO INDICATED THAT WORK SHALL BE IN ACCORDANCE TO THE ATAT GROUNDING STANDARDS, MORE SPECIFICALLY, ALL CONNECTIONS SHALL BE MADE WITH AN EXOTHERMIC WELD PROCESS, WHERE EXOTHERMIC WELDS ARE NOT POSSIBLE, A 2-HOLE COMPRESSION TYPE LUG IS PERMITTED.

3. REVISE THE GROUNDING DETAL TO INDICATE THAT SIZE OF THE GROUNDING CONDUCTOR SHALL BE PER AT&T STANDARDS, NO SIZE IS INDICATED ON THE EXISTING DETAIL.

Grounding detail 1 / A-4 has bee revised with New Note and Size of Grounding Cable has been added to the detail

4. REVISE AND DISTRIBUTE DRAWINGS WITH CORRECTION FOR FINAL APPROVAL

END OF COMMENTS

STRUCTURAL COMMENTS:

THE AT&T BUILDING IS A PUBLIC UTILITY FACILITY. THE LATERAL LOAD ANALYSIS SHALL BE BASED ASCE CATECORY THREE REQUIREMENTS WITH 115 MPH WIND LOAD, REVISE ANTENNA WIND LOAD ANALYSIS ON CALCULATION PAGE 3 ACCORDING TO THE CATEGORY THREE REQUIREMENTS, REVISE ANTENNA WIND LOAD ANALYSIS ON CALCULATION FAGE 3 ACCORDING TO THE CATEGORY THREE REQUIREMENTS AND RECOSIGN THE ANTENNA SUPPORT AS

RESPONSE: THE WIND LOADING HAS BEEN CHANGED TO 115 MPH, PLEASE SEE THE REVISED

2. AT SECTOR A, NEW STEEL ANGLES ARE ADDED TO SUPPORT THE PROPOSED ANTENNA, PROVIDE ENGINEERING ANALYSIS AND DESIGN TO JUSTIPY THE ADEQUACY OF THE STEEL ANGLES TO SUPPORT THE ANTENNAS, DESIGN AND PROVIDE END CONNECTION DETAILS OF THE STEEL ANGLES TO ANGLE TO THE EXISTING POLIC CONNECTION, DEPORT THE STEEL ANGLES REACTION AND THE EXISTAL CADAS FROM THE ADDED ANTENNA PER WALL ELEVATION ON A -3, THE SYMPHONA WILL BE MOUNTED TO THE EXISTING CANTILEVER POLIC OFF THE PARAPET WALL. YERRY THE ADEQUACY OF THE STEEL POLE, WALL ANCHORAGE TO SUPPORT THE TAILED ANTENNA, YERRY THE ADEQUACY OF THE EXISTING PARAPET WALL AND SCREEN WALL TO SUPPORT THE REACTION FORCES FORM THE ADDED ANTENNA.

RESPONSE: PLEASE SEE THE REVISED STRUCTURAL CALCULATIONS PAGES 7 AND 8.

VERIFY THE ADEQUACY OF THE ANTENNA TO METAL STUD WALL ANCHORAGE DETAIL SHOWN ON 6/A-4. THE 1/2 THROUGH BOLTS COULD BE SUPPORTED BY THE EXTERIOR STUCCO ON BOTH SIDES OF THE WALL ONLY, WHICH DOES NOT HAVE THE STRENGTH TO SUPPORT THE PROPOSED ANTENNA, DESIGN AND REVISE ANTENNA ANCHORAGE DETAIL IN METAL STUD WALL ACCORDINGLY, VERIFY THE ADEQUACY OF THE METAL STUD TO SUPPORT THE ADDED LOADS FROM THE PROPOSED ANTENNA.

RESPONSE: PLEASE SEE THE REVISED STRUCTURAL CALCULATIONS PAGE 7

4. AT SECTOR C, THE PROPOSED ANTENNA MOUNTED TO THE END OF THE SCREEN WALL DOES NOT REFLECT THE ACTUAL SITE CONDITION. THE ANTENNA SHALL BE CESCIEND AND DETAILED TO MOUNT TO THE EASTING SCREEN WALL STEEL BRACE PER STEE CONDITION.

RESPONSE: PLEASE SEE THE REVISED PLANS, SHEET A-2

5. PLE PROCESS. PLEASE PROVIDE WRITTEN RESPONSES TO EACH REVIEW COMMENT TO FACILITATE REVIEW

RESPONSE: NOTED.

MICHAEL NI & ASSOCIATES CONSULTING STRUCTURAL ENGINEERS 1414 FAIR OAKS AVENUE, SUITE 11 SOUTH PASADENA, CA 91030 (626)799-3588

SEPTEMBER 29, 2015

MR. JOHN CHAN JTC ARCHITECTS 65 N. FIRST AVENUE, SUITE 201

DEAR MR, CHAN:
PURSUMNIT TO YOUR REQUEST, WE HAVE REVIEWED THE REVISED STRUCTURAL CALCULATIONS AND
DRAWINGS PROVIDED BY THE CONNELL DESIGN CROUP DATED SEPTEMBER 12, 2015. THE
PROVIDED CALCULATIONS AND DRAWINGS ARE PERTAINING TO THE PROPOSED AVIENNAS MODIFICATION
AND PANELS INSTILLATION OF THE ABOVE REFERENCES DIE. FOLLOWINGS ARE THE STRUCTURAL REVIEW

AT SECTOR A, THE PROPOSED ANTENNA IS MOUNTED TO THE EXISTING BRICK PARAPET WALL PER DETAIL 2/A-2, PROVIDE ANTENNA ANCHORAGE DESIGN AND DETAILS ON PLAN OF ATTACHMENT TO THE BRICK PARAPET WALL, PROVIDE A FULL HEIGHT SECTION OF THE ANTENNA SUPPORT ON PLAN TO FACILITATE CONSTRUCTION.

ANTENNAS AT SECTOR "A" HAVE BEEN RELOCATED TO THE FACE OF CONVENTIONAL MATERIAL SCREENING PER CITY REQUEST SEE DETAILS 1/A-1.2 AND 2/A-2

2. PROVIDE ENGINEERING ANALYSIS TO JUSTIFY THE ADEQUACY OF THE ANTENNA TO METAL STUD WALL ANCHARGE DETAIL SHOWN ON 6/A-4. THE 1/2-THROUGH BOUTS COLLO BE SUPPORTED BY THE EXTERIOR STUCCO ON BOTH SIDES OF THE WALL ONLY, WHICH DOES NOT HAVE THE STRENGTH TO SUPPORT THE PROPOSED ANTENNA, DESIGN AND REVISE ANTENNA ANCHORAGE

SEE NEW DETAIL SHOWING EXISTING 3 1/2" SQ. STEEL TUBE SCREEN POSTS INSIDE OF SCREEN WAL NEW DETAILS SHOWS 5'-0" LONG 3"x3"x1/4" ANGLES ATTACHED TO (E) STEEL POSTS WITH 1/2" THRU BOLTS

3. AT SECTOR C, THE PROPOSED ANTENNA MOUNTED TO THE END OF THE SCREEN WALL DOES NOT REFLECT THE ACTUAL SITE CONDITION. THE ANTENNA SHALL BE DESIGNED AND DETAILED TO MOUNT TO THE EXISTING SCREEN WALL STEEL BRACE PER SITE CONDITION.

SFF NFW ANTENNA MOUNTING DETAIL 2/A-6

4. PLEASE PROVIDE WRITTEN RESPONSES TO EACH REVIEW COMMENT TO FACILITATE REVIEW PROCESS.

IF YOU HAVE ANY QUESTIONS, PLEASE FEEL FREE TO CONTACT US: MICHAEL NI, S.E.

PLANS PREPARED BY:



- CONSULTING GROUP: -



16150 Scientific Wav Irvine, CA 92618

-DATE: DESCRIPTION 09/08/1 90% CD'S HL 0/08/1 HL 100% CD'S DC 100% CD"S 2/03/15 GN 100% CD'S 6/26/15 FC 100% CD'S JPC 07/16/15 100% CD'S 08/19/15 100% CD'S SA 09/16/15 100% CD'S DĊ 09/28/15 SA 100% CD'S 0/30/15 100% CD'S SA

- SITE INFORMATION:

CM049 LE103

LA02049A

1786 ORANGE AVE.. COSTA MESA, CA 92626

- SHEET TITLE: -

-SEAL:

PLAN REVIEW COMMENTS

- SHEET NUMBER: -

LA02049A CM 049 LE103

1786 Orange Avenue Costa Mesa, CA 92626

VIEW 2

APPLICANT
T-Mobile
2008 McGaw Avenue
Irvine, CA 92614

CONTACT

Coastal Business Group Inc. 16150 Scientific Way Irvine, CA 92618 p 949.336.1550



BLUE WATER DESIGN
bluewater-design.net
michelle @ bluewater-design.net
p 714.473.2942



LA02049A CM 049 LE103 1786 Orange Avenue Costa Mesa, CA 92626

VIEW 1

APPLICANT
T-Mobile
2008 McGaw Avenue
Irvine, CA 92614

Coastal Business Group Inc. 16150 Scientific Way Irvine, CA 92618 p 949.336.1550

CONTACT

Completed November 09, 2015



BLUE WATER DESIGN bluewater-design.net michelle@bluewater-desi p 714.473.2942

PROPOSED NEW & RELOCATED ANTENNA LOCATION

LA02049A CM 049 LE103

1786 Orange Avenue Costa Mesa, CA 92626

VIEW 3

APPLICANT
T-Mobile
2008 McGaw Avenue
Irvine, CA 92614

Coastal Business Group Inc. 16150 Scientific Way Irvine, CA 92618 p 949.336.1550

CONTACT

Completed November 09, 2015



BLUE WATER DESIGN
bluewater-design.net
michelle@bluewater-design.net
p 714.473.2942



LA02049A CM 049 LE103

1786 Orange Avenue Costa Mesa, CA 92626

VIEW 4

APPLICANT T-Mobile 2008 McGaw Avenue Irvine, CA 92614

CONTACT

Coastal Business Group Inc. 16150 Scientific Way Irvine, CA 92618 p 949.336.1550



BLUE WATER DESIGN
bluewater-design.net
michelle @ bluewater-design.net
p 714.473.2942 Blue Water